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Landscape Architects • Planners **Drawn By** BC **Project Mgr**. DAS Drawing File 08321024-PUD-00 X-Reference Files 08321024-BAS-00 DEMO

01/17/17

Date No. Revision/Issue By Date

PLANT SCHEDULE, NOTES & DETAILS


Sheet Title	
ZONE MODIFIC	CATION PLAT
Project No.	08321.02
Scale	1'=40'
Sheet No.	C001
File No.	08-321

Utilities Protection

SERVICE

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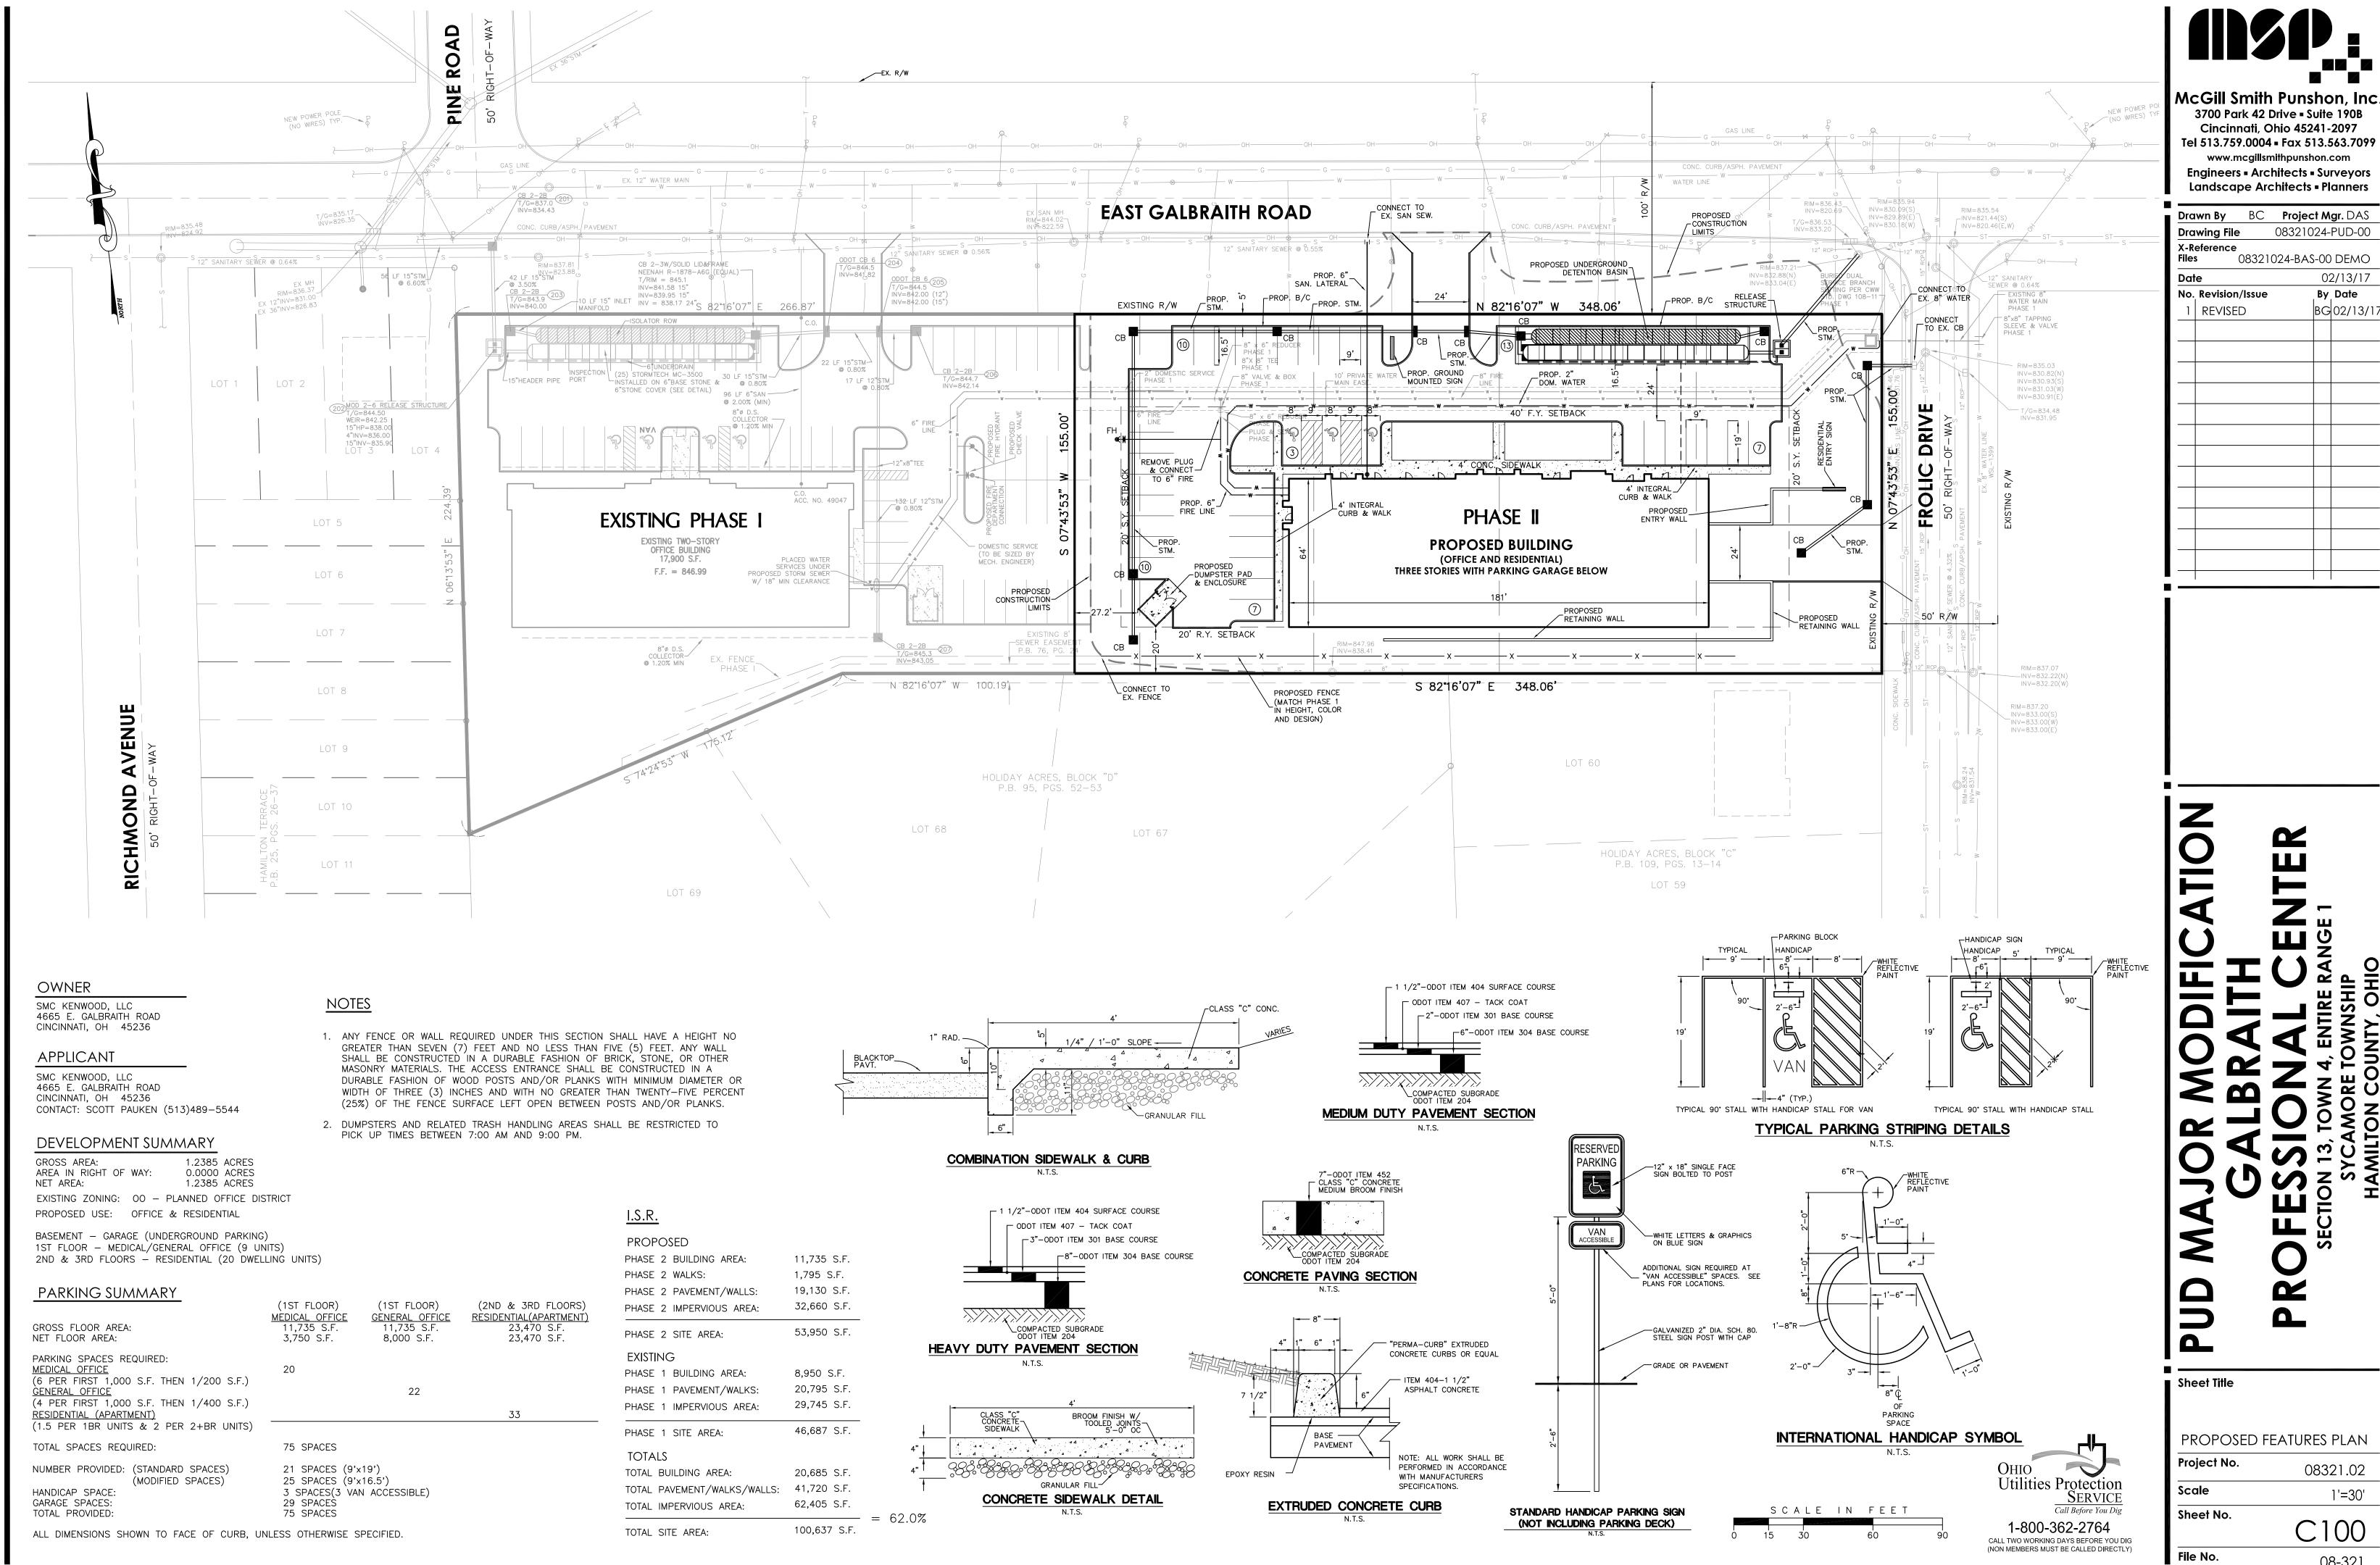
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01/17/17 No. Revision/Issue By Date

EXISTING FEATURES 08321.02

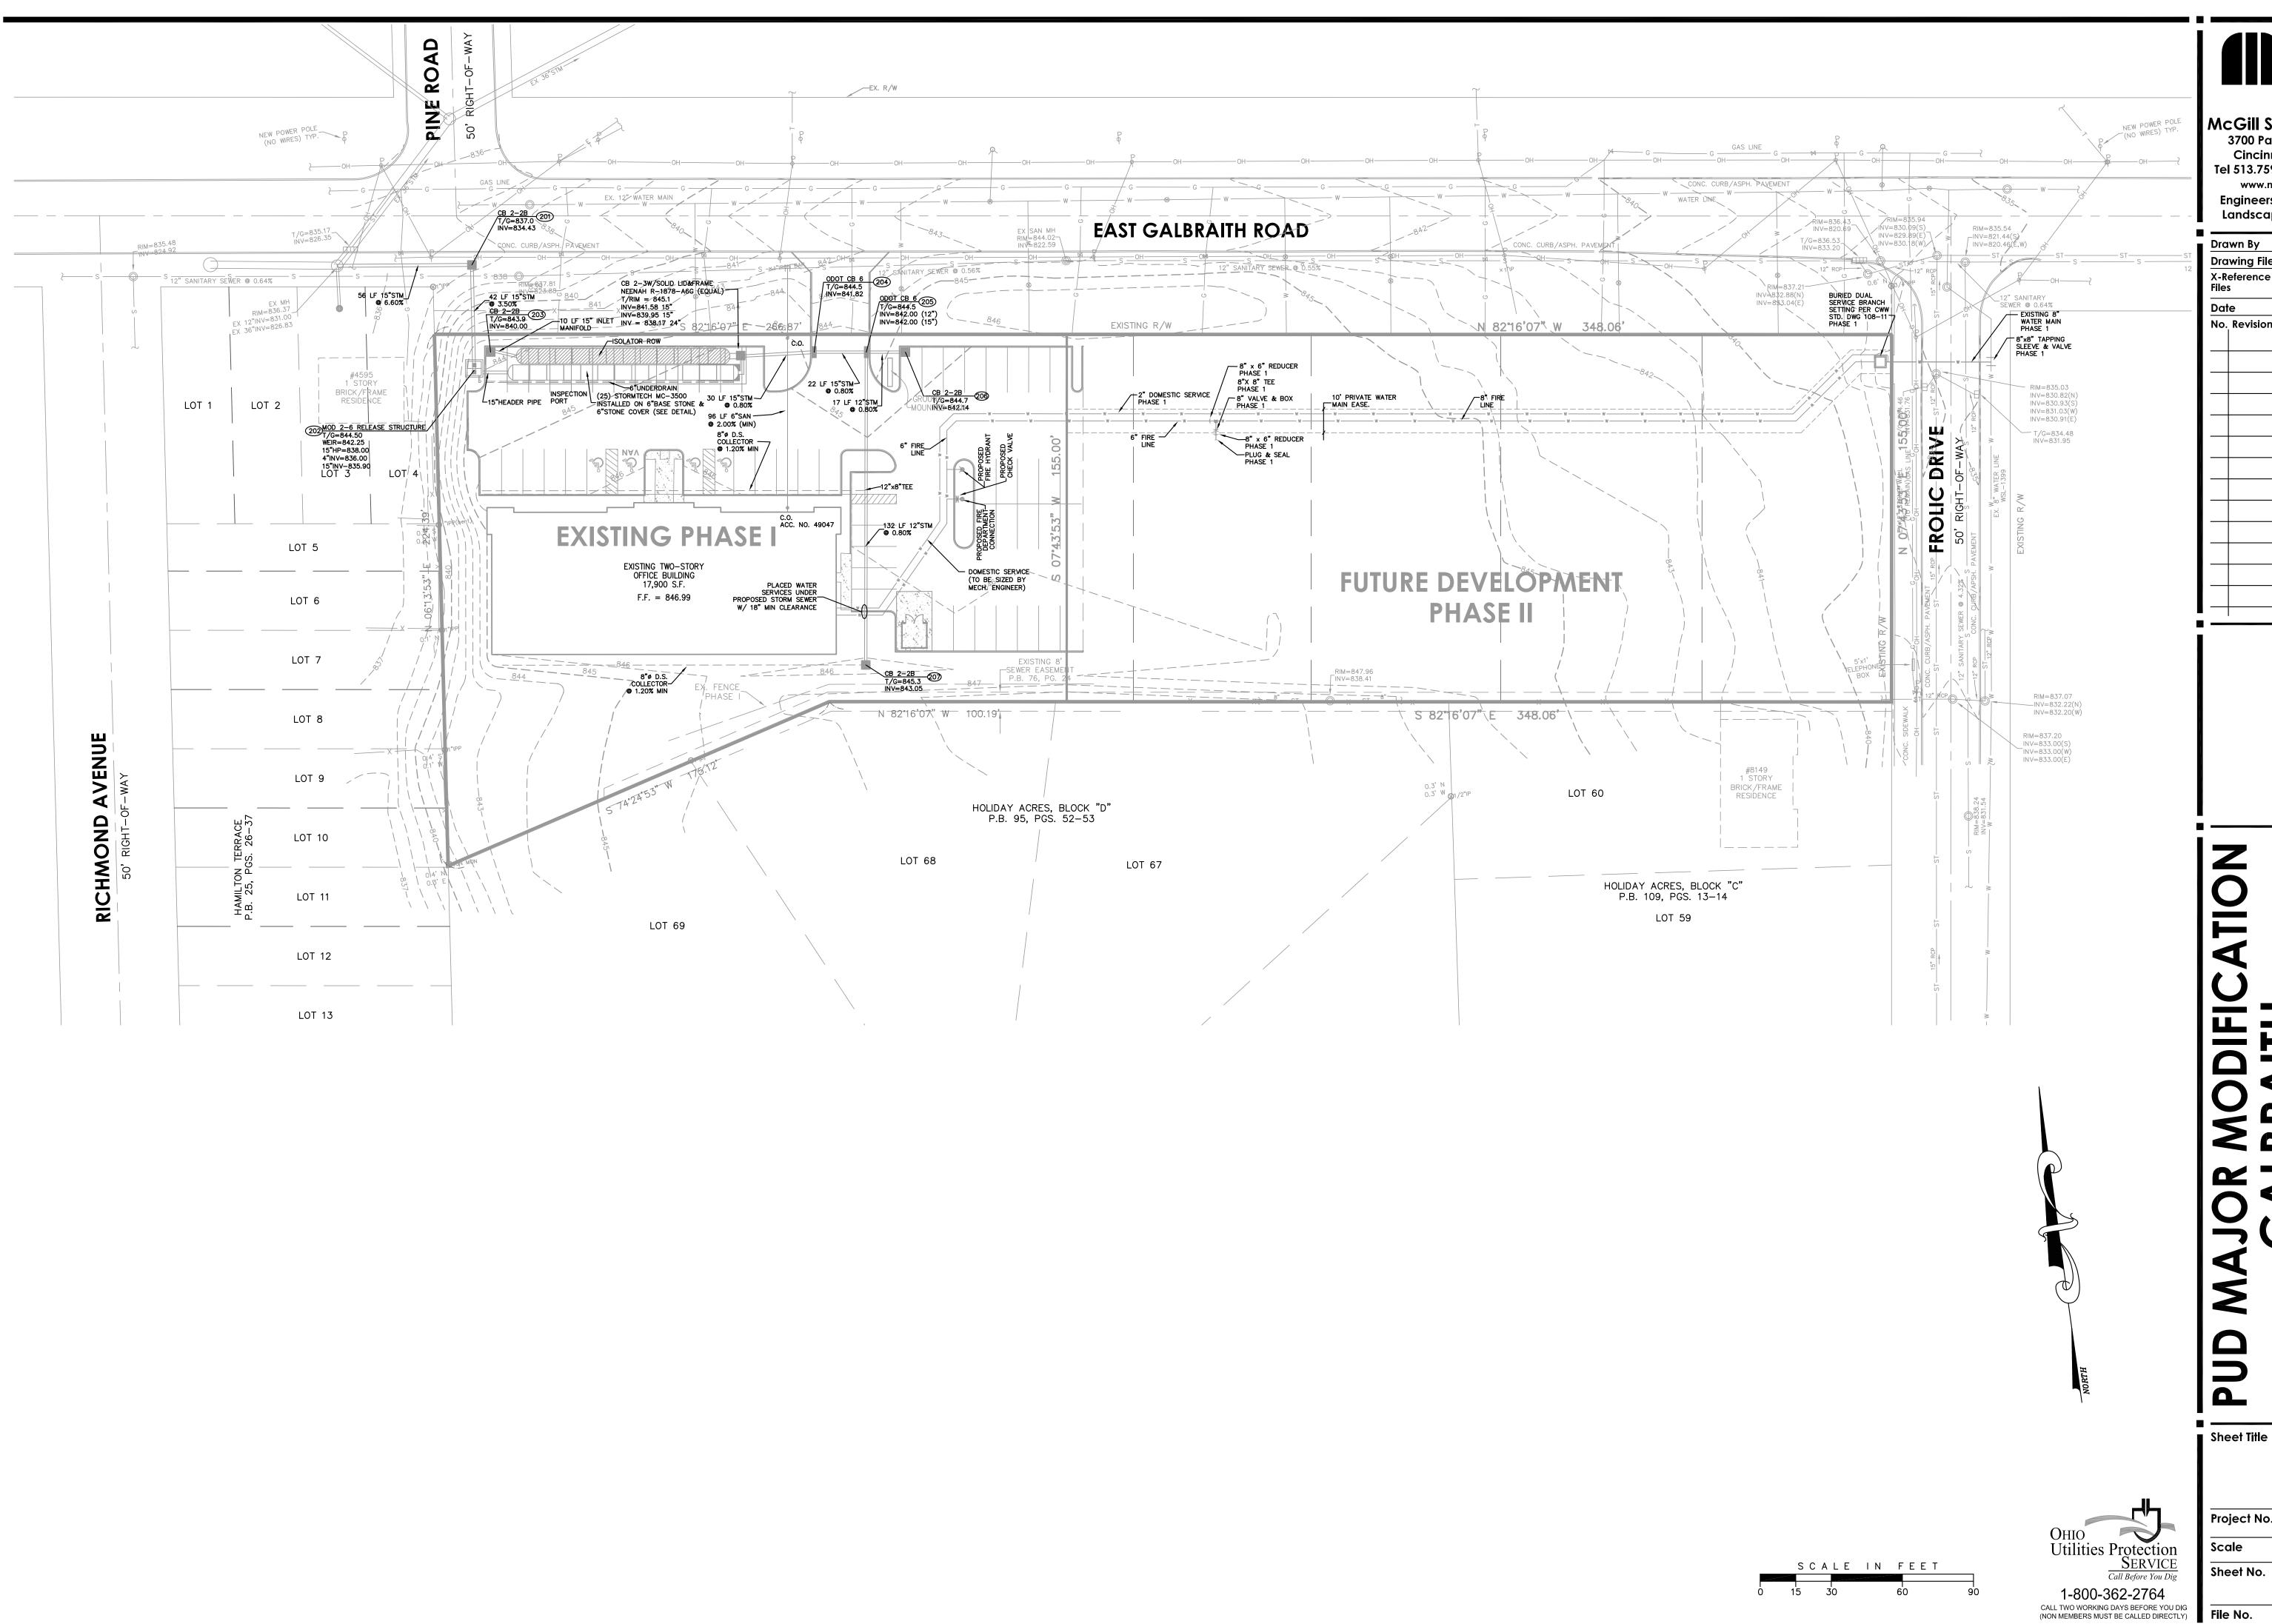08-321

1'=30'




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Drawn By BC Project Mgr. DAS 08321024-PUD-00 08321024-BAS-00 DEMO 02/13/17 By Date BG 02/13/1

> PROPOSED FEATURES PLAN 08321.02

> > 1'=30'

08-321

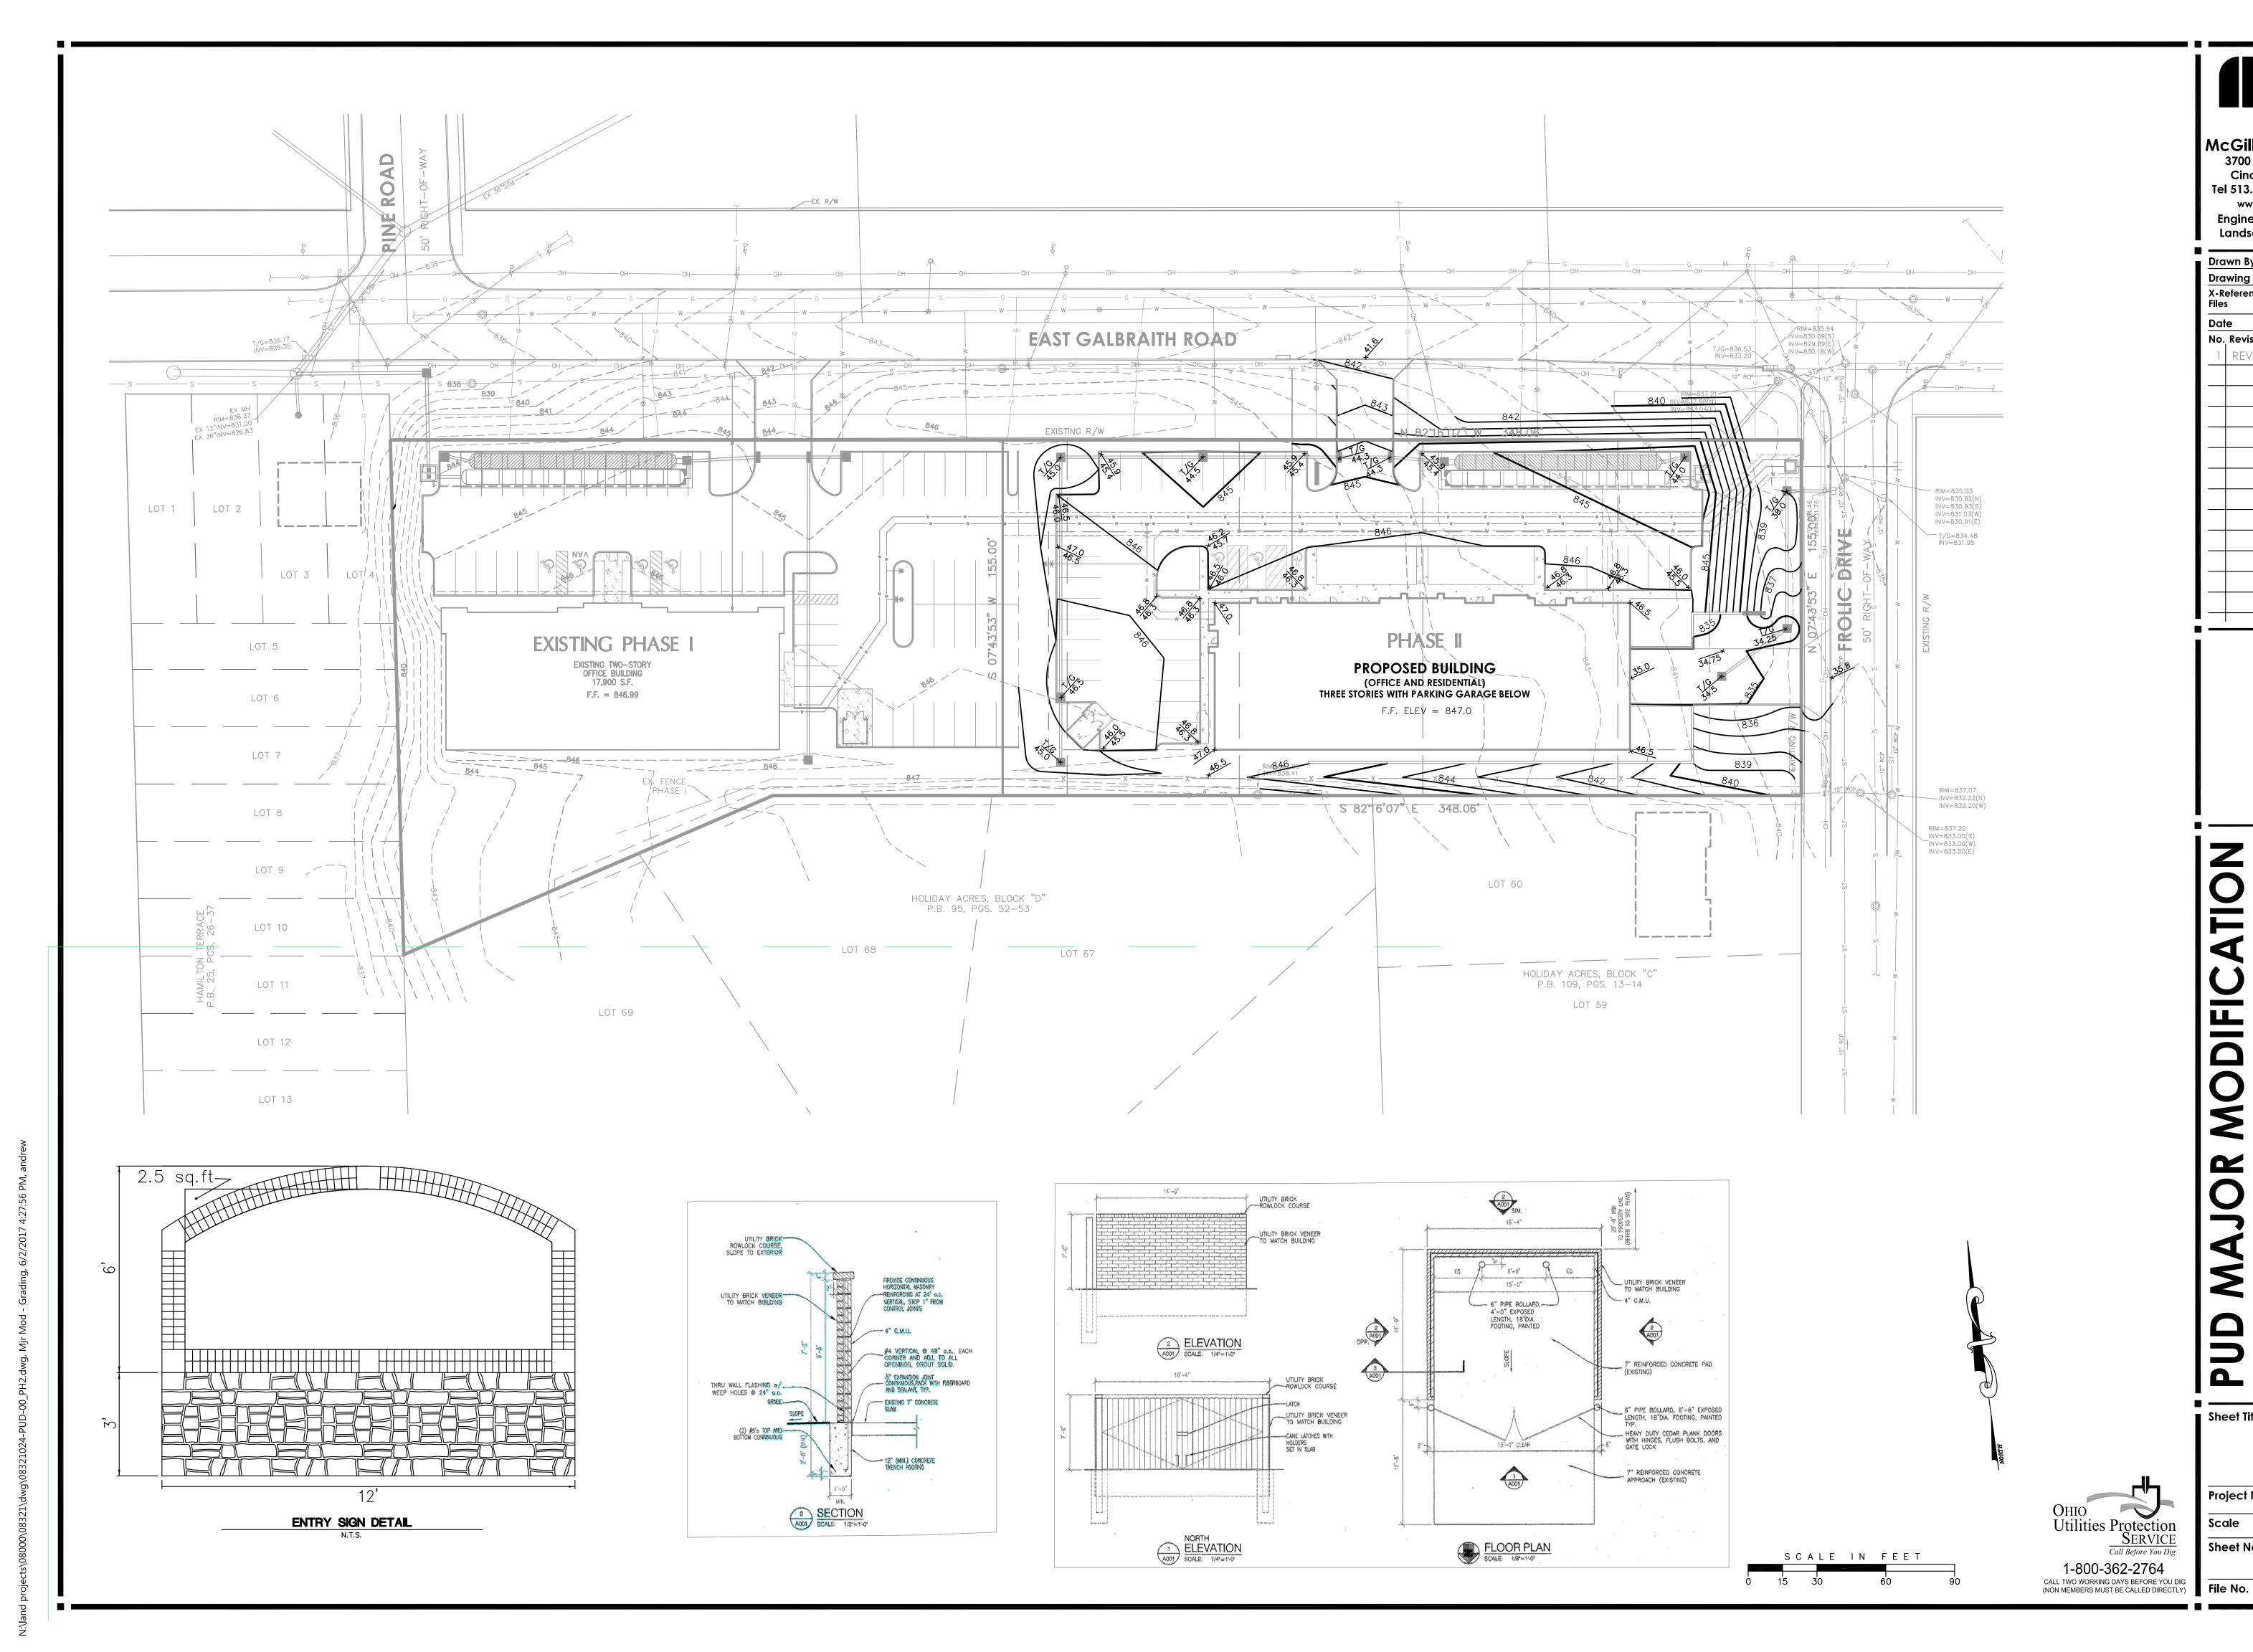

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Files 08321024-BAS-00 DEMO

Date 02/13/17

No. Revision/Issue By Date

1 REVISED BG 02/13/17


PUD MAJOR MODIFICATION GALBRAITH

GRADING PLAN

Project No. 08321.02

Scale 1'=30'
Sheet No. C200

File No. 08-321

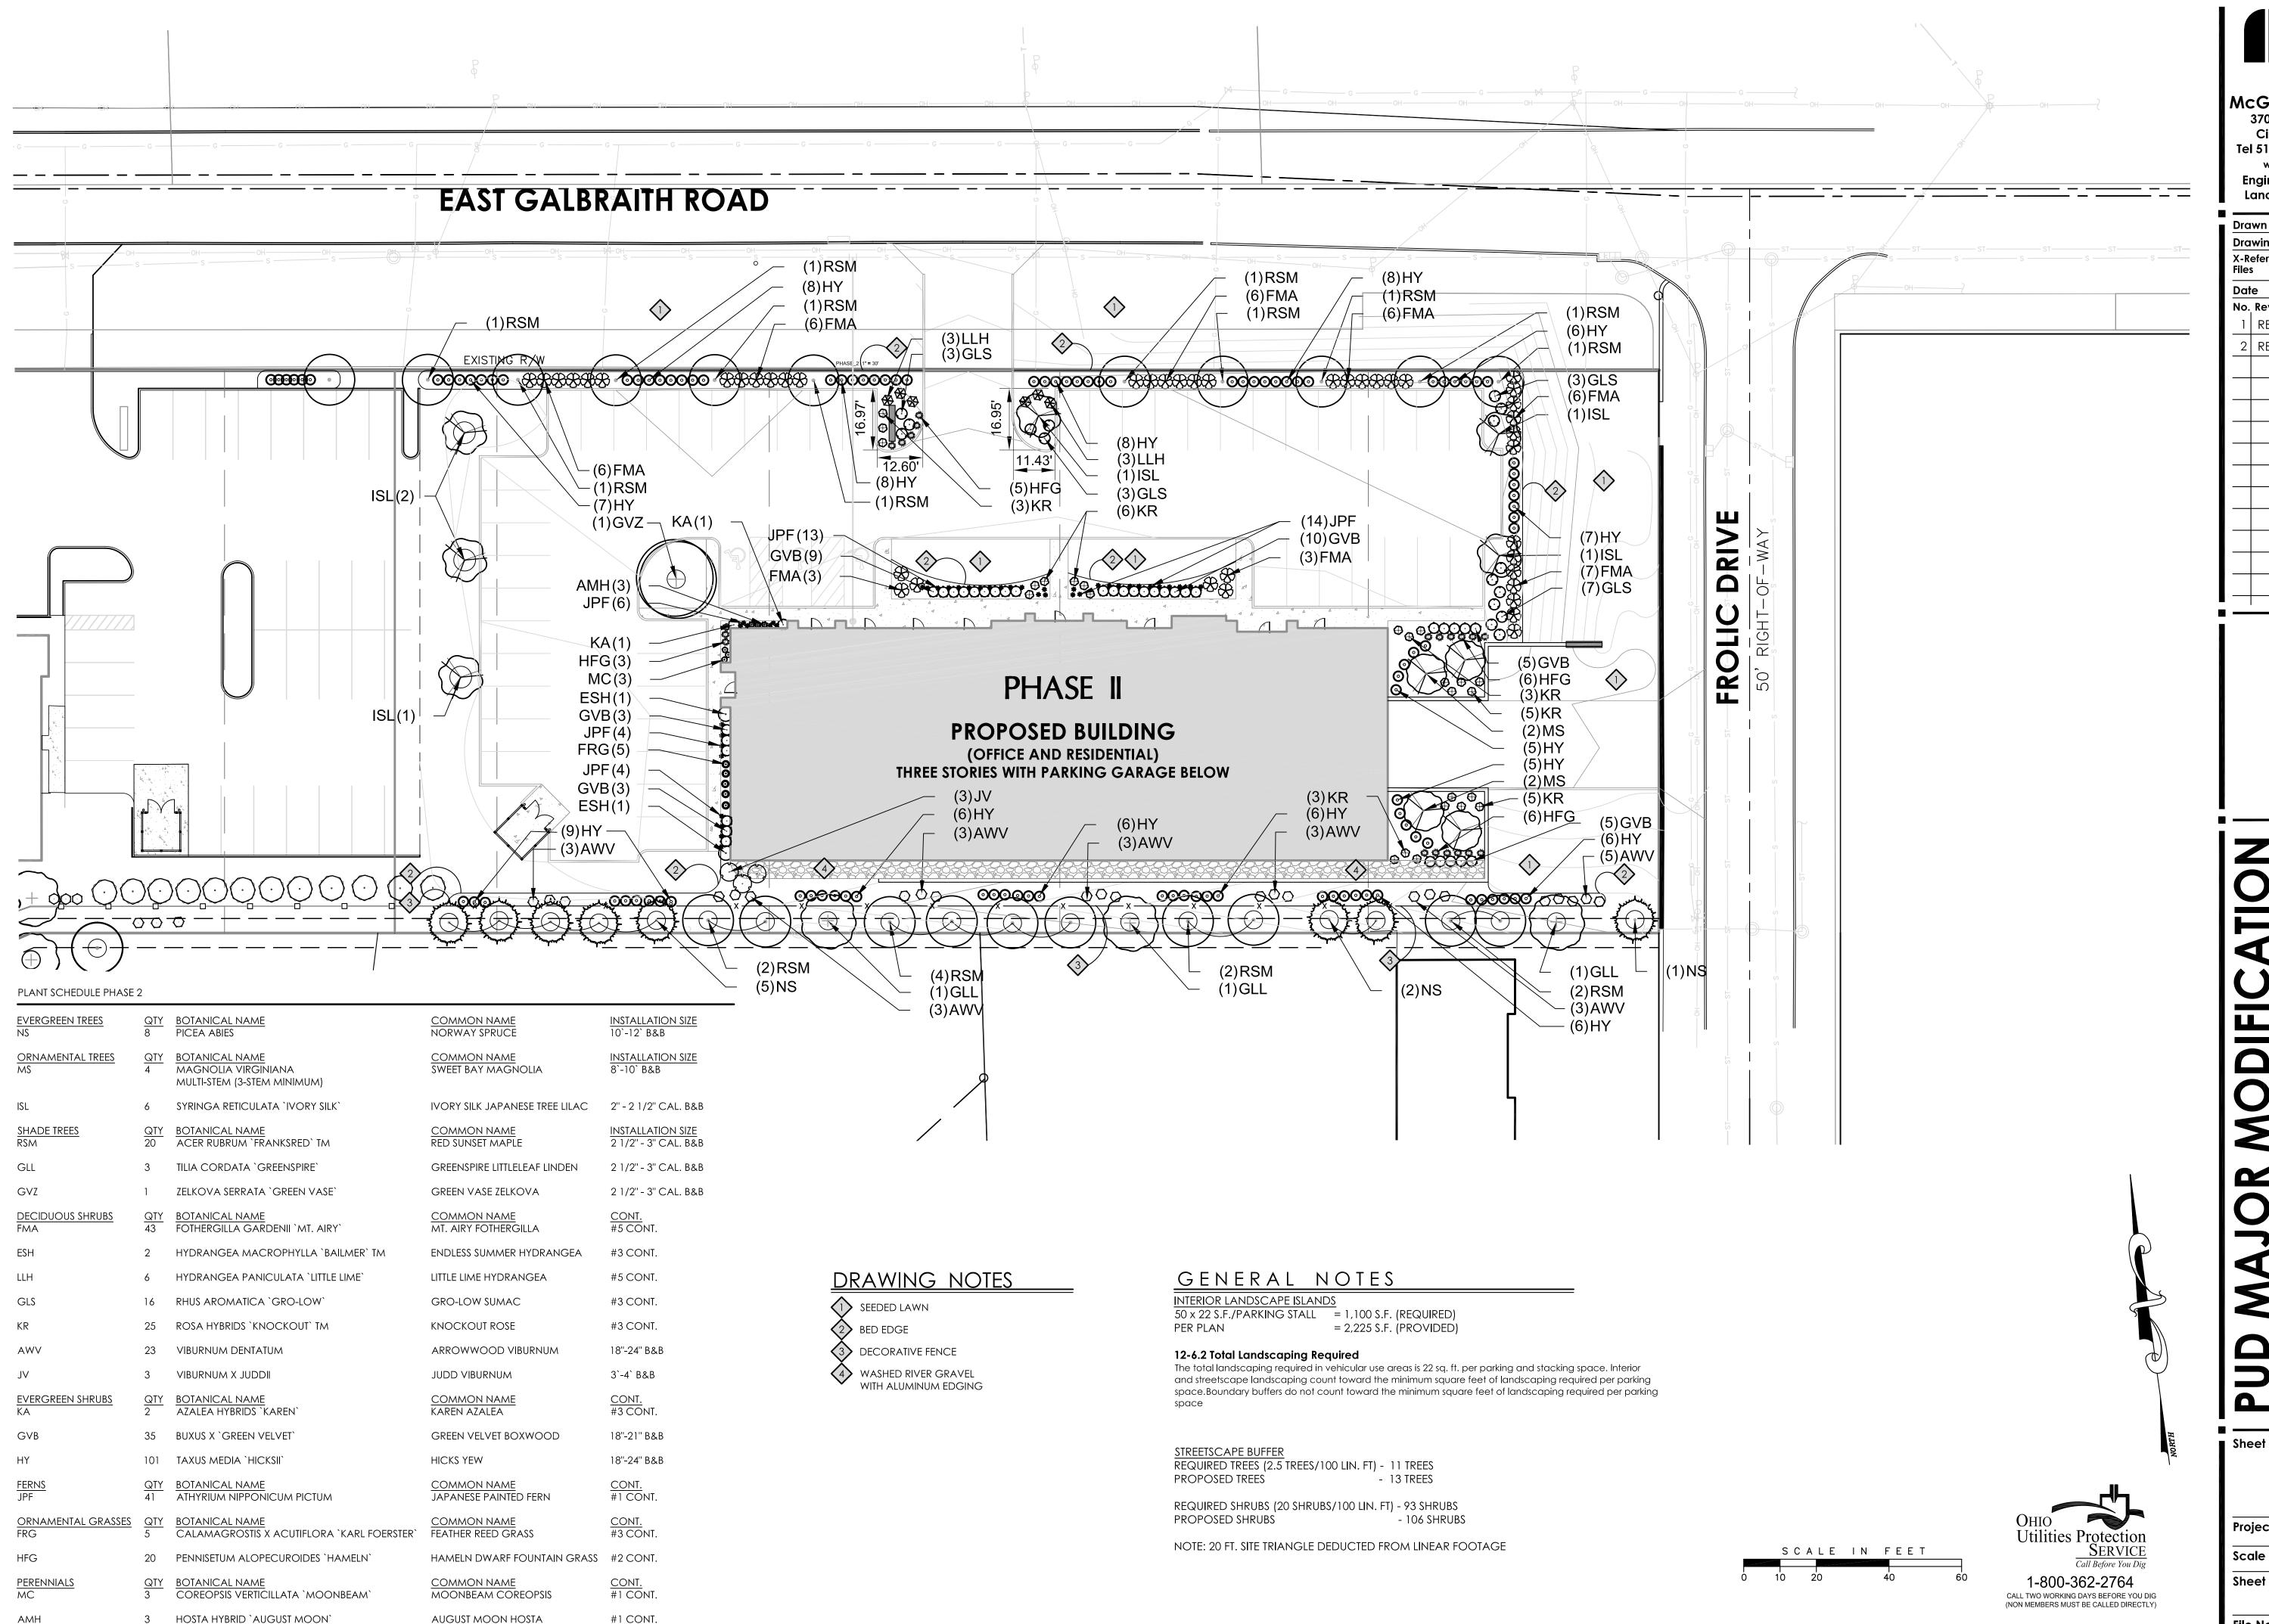




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	2	REVIS	ED		ВG	06/07/17	

Sheet Title

LANDSCAPE PLAN Project No. 08321.02 1'=20'


Sheet No. File No. 08-321

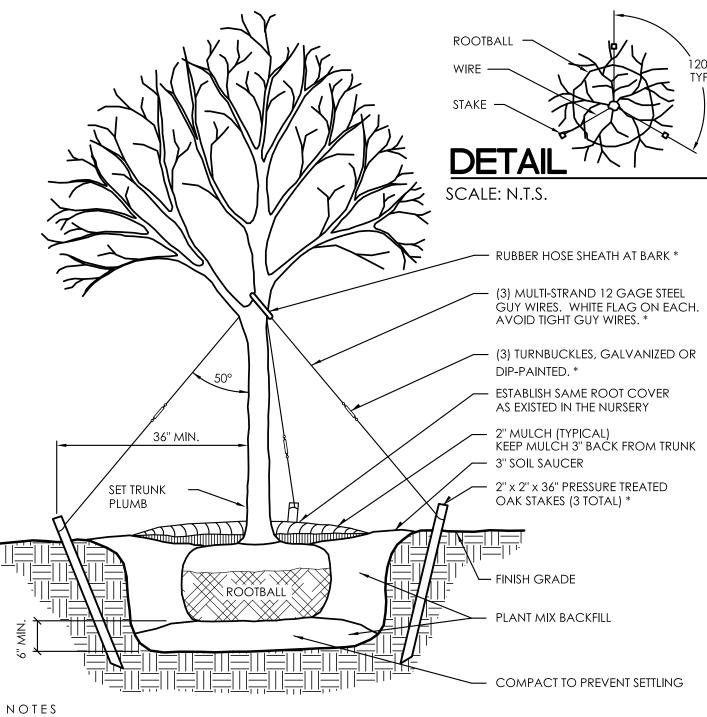

- 1. IF NOT READILY APPARENT, LOCATE TRUNK FLARE BY REMOVING TWINE, BURLAP, AND EXCESS SOIL.
- 2. DIG TREE HOLE AT LEAST TWO TIMES WIDER THAN THE ROOT BALL, WITH SIDES SLOPED TO AN UNEXCAVATED OR FIRM BASE. DIG HOLE TO A DEPTH SO THE LOCATED TRUNK FLARE, AT THE FIRST ORDER LATERAL ROOT, WILL BE AT FINISHED GRADE.
- 3. LIFTING ONLY FROM THE BOTTOM OF THE ROOT BALL, POSITION TREE ON FIRM PAD SO THAT IT
- IS STRAIGHT AND TOP OF FLARE IS LEVEL WITH THE SURROUNDING SOIL. 4. REMOVE ALL TWINE FROM ROOT BALL. IF PRESENT, REMOVE AND DISCARD THE TOP 3"
- OF BURLAP FROM THE ROOT BALL. 5. WITH CLEAN, SHARP PRUNING TOOLS, PRUNE OFF ANY SECONDARY/ADVENTITIOUS, GIRDLING, AND
- POTENTIAL GIRDLING ROOTS. 6. BACKFILL PLANTING HOLE WITH PLANT MIX (SEE GENERAL NOTES), AND THOROUGHLY WATER.
- 7. MULCH ENTIRE PLANTING SURFACE WITH COMPOSTED BARK MULCH APPLIED NO LESS THAN TWO INCHES (2") DEEP AND NO MORE THAN THREE INCHES (3") DEEP, LEAVING THREE INCHES (3") ADJACENT TO THE TREE TRUNK FREE OF MULCH.
- 8. STAKE DECIDUOUS TREES WITH A 2 1/2" OR GREATER CALIPER.
- 9.* REMOVE STAKES 1 YEAR AFTER PLANTING.


DECIDUOUS TREE STAKING + GUYING

SCALE: N.T.S.

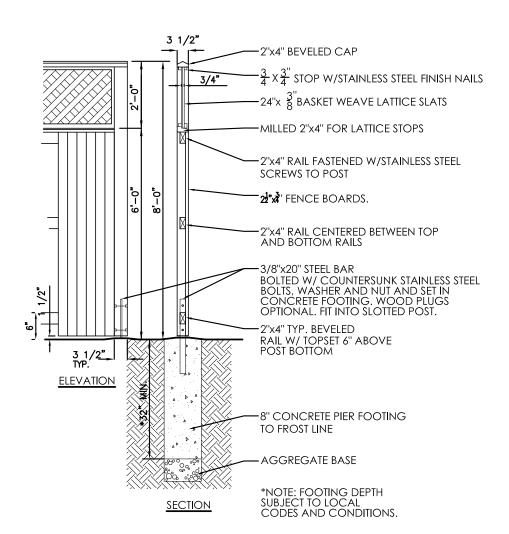

DETAIL

DESCRIPTION: VINYL FENCE WITH LATTICE SCALE: N.T.S.

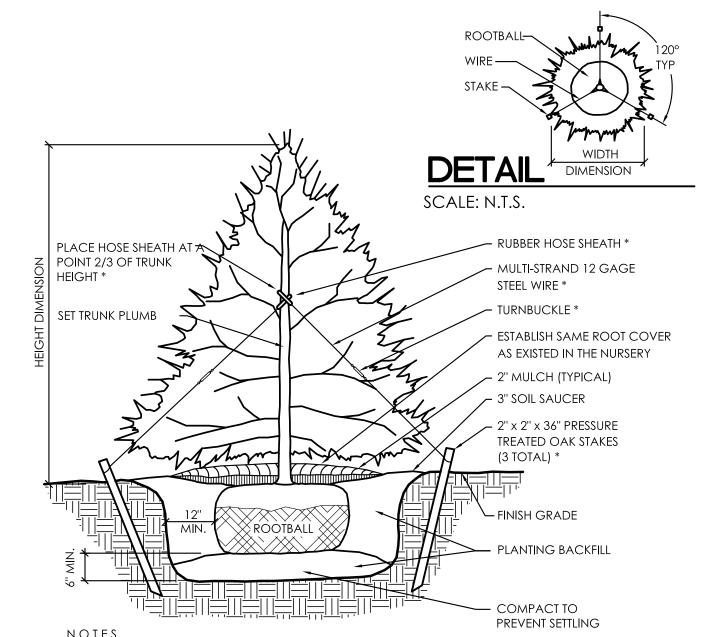


- 1. IF NOT READILY APPARENT, LOCATE TRUNK FLARE BY REMOVING TWINE, BURLAP, AND EXCESS SOIL.
- 2. DIG TREE HOLE AT LEAST TWO TIMES WIDER THAN THE ROOT BALL, WITH SIDES SLOPED TO AN UNEXCAVATED OR FIRM BASE. DIG HOLE TO A DEPTH SO THE LOCATED TRUNK FLARE, AT THE FIRST ORDER LATERAL ROOT, WILL BE AT
- 3. LIFTING ONLY FROM THE BOTTOM OF THE ROOT BALL, POSITION TREE ON FIRM PAD SO THAT IT IS STRAIGHT AND TOP OF FLARE IS LEVEL WITH THE SURROUNDING SOIL.
- 4. REMOVE ALL TWINE FROM ROOT BALL. IF PRESENT, REMOVE AND DISCARD TOP 3" OF BURLAP FROM THE ROOT
- 5. WITH CLEAN, SHARP PRUNING TOOLS, PRUNE OFF ANY SECONDARY/ADVENTITIOUS, GIRDLING, AND POTENTIAL GIRDLING ROOTS.
- 6. BACKFILL PLANTING HOLE WITH PLANT MIX (SEE GENERAL NOTES), AND THOROUGHLY WATER.
- 7. PROVIDE WATER CRYSTALS PER MANUFACTURER'S RECOMMENDATION.
- 8. MULCH ENTIRE PLANTING SURFACE WITH COMPOSTED BARK MULCH APPLIED NO LESS THAN TWO INCHES (2") DEEP AND NO MORE THAN THREE INCHES (3") DEEP, LEAVING THREE INCHES (3") ADJACENT TO THE TREE TRUNK FREE OF
- 9.* EVERGREEN TREES WITH 2" CALIPER OR SMALLER SHALL BE STAKED. EVERGREEN TREES HAVING A HEIGHT OF 7' OR GREATER SHALL BE STAKED.
- 10.* REMOVE STAKES 1 YEAR AFTER PLANTING.

EVERGREEN TREE STAKING & GUYING

SCALE: N.T.S.

NOTES

- 1. CUT AND REMOVE BURLAP FROM TOP 1/3 OF ROOTBALL. IF CONTAINER IS USED, REMOVE CONTAINER AND LIGHTLY HAND SCARIFY ALL SIDES OF THE ROOT SYSTEM. 2. SHRUB SHALL BEAR SAME RELATION TO FINISH GRADE
- AS IT DID TO PREVIOUS GRADE.

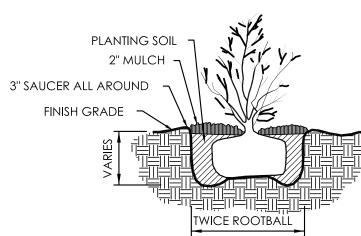

SHRUB PLANTING

SCALE: N.T.S.

GENERAL NOTES - PLANTING

- 1. LANDSCAPE CONTRACTOR IS TO VERIFY LOCATIONS OF ALL UTILITIES WITH THE OWNER, OWNER'S REPRESENTATIVE, GENERAL CONTRACTOR, CONSTRUCTION MANAGER OR DESIGN BUILDER AND UTILITY COMPANIES PRIOR TO BEGINNING CONSTRUCTION. LANDSCAPE CONTRACTOR IS RESPONSIBLE FOR DETERMINING IN THE FIELD ACTUAL LOCATIONS AND ELEVATIONS OF EXISTING UTILITIES, WHETHER INDICATED ON PLANS OR NOT. LANDSCAPE CONTRACTOR MUST CALL THE UTILITIES PROTECTION SERVICE A MINIMUM OF 48 HOURS PRIOR TO CONSTRUCTION. LANDSCAPE CONTRACTOR SHALL BE FULLY RESPONSIBLE FOR DAMAGE OF UTILITY LINES. WHICH IS CAUSED BY THEIR ACTIONS OR THE ACTIONS OF THEIR
- 2. LANDSCAPE CONTRACTOR TO EXAMINE FINISH SURFACE, GRADE ACCURACY AND TOPSOIL FOR DEPTH AND QUALITY; REFER TO SPECIFICATIONS (IF APPLICABLE); IF CONDITIONS ARE UNSATISFACTORY, NOTIFY OWNER, OWNER'S REPRESENTATIVE, GENERAL CONTRACTOR, CONSTRUCTION MANAGER OR DESIGN BUILDER AND DO NOT BEGIN WORK UNTIL CONDITIONS HAVE BEEN CORRECTED.
- 3. AFTER INSTALLATION, REPAIR ALL DAMAGES MADE TO EXISTING CONDITIONS TO OWNER'S REPRESENTATIVE'S SATISFACTION.
- 4. PLANT MATERIALS SHALL CONFORM TO THE STANDARDS OF THE AMERICAN NURSERY AND LANDSCAPE ASSOCIATION AND SHALL HAVE PASSED INSPECTION REQUIRED UNDER STATE REGULATIONS. CALL (202)-789-2900 TO OBTAIN A COPY OF THE AMERICAN STANDARD FOR NURSERY STOCK BOOKLET.
- 5. NURSERY STOCK IDENTIFICATION TAGS SHALL NOT BE REMOVED FROM ANY PLANTING PRIOR TO INSPECTION AND APPROVAL OF INSTALLATION BY THE OWNER'S REPRESENTATIVE.
- 6. ALL PLANTINGS TO BE CONTAINED WITHIN BARK MULCHED BED. ALL TREES LOCATED WITHIN LAWN AREAS TO BE CONTAINED WITH A 5' MULCH RING. BARK MULCH SHALL BE FINELY SHREDDED HARDWOOD, DARK IN COLOR.
- 7. SEED ALL DISTURBED LAWN AREAS THAT ARE NOT LANDSCAPED.
- 8. LANDSCAPE CONTRACTOR, GENERAL CONTRACTOR, CONSTRUCTION MANAGER OR DESIGN BUILDER IS RESPONSIBLE FOR MAINTAINING POSITIVE DRAINAGE IN LAWN AREAS. LANDSCAPE CONTRACTOR IS RESPONSIBLE FOR PLANT'S LIVABILITY. REFER TO FRONT END SPECIFICATIONS IF APPLICABLE.
- 9. ANY LANDSCAPE CONTRACTOR RECOMMENDED SUBSTITUTIONS MUST BE APPROVED BY THE LANDSCAPE ARCHITECT. UNAPPROVED SUBSTITUTIONS SHALL BE REMOVED AND REPLACED WITH APPROPRIATE PLANTS.
- 10. A COMPLETE LIST OF PLANTS, INCLUDING A SCHEDULE OF SIZES, QUANTITIES, AND OTHER COMMENTS IS SHOWN ON THE DRAWINGS (IF REQUIRED). IN THE EVENT THAT QUANTITY DISCREPANCIES OR MATERIAL OMISSIONS OCCUR IN THE PLANT SCHEDULE, THE PLANTING PLANS SHALL GOVERN.
- 11. GENERAL CONTRACTOR, CONSTRUCTION MANAGER, DESIGN BUILDER OR LANDSCAPE CONTRACTOR IS RESPONSIBLE FOR COMPLIANCE WITH ALL FEDERAL, STATE AND LOCAL ORDINANCES AND SHALL MAKE CONSULTANTS AWARE OF THESE ORDINANCES.
- 12. GENERAL CONTRACTOR, CONSTRUCTION MANAGER, DESIGN BUILDER OR LANDSCAPE CONTRACTOR TO COORDINATE CONSTRUCTION STAGING AND MATERIAL STOCKPILING WITH THE OWNER OR OWNER'S REPRESENTATIVE.
- 13. DURING ALL PHASES OF CONSTRUCTION ACTIVITY, IF THE LANDSCAPE CONTRACTOR OR THEIR SUBS ENCOUNTER ANY "SOLID WASTE MATERIAL" (EXCLUDING CLEAN HARD FILL) THE GENERAL CONTRACTOR, CONSTRUCTION MANAGER, DESIGN BUILDER, OWNER OR OWNER'S REPRESENTATIVE SHALL BE CONTACTED IMMEDIATELY FOR FURTHER DIRECTION.
- 14. LANDSCAPE CONTRACTOR SHALL CLEAN STREETS OF MUD AND DEBRIS GENERATED BY THEIR CONSTRUCTION ACTIVITIES OR THEIR SUB'S CONSTRUCTION ACTIVITIES, PURSUANT WITH LOCAL CODE REQUIREMENTS.
- 15. LANDSCAPE CONTRACTOR TO COORDINATE WITH THE GENERAL CONTRACTOR, CONSTRUCTION MANAGER, DESIGN BUILDER, OWNER OR OWNER'S REPRESENTATIVE TO PROVIDE FOR APPROPRIATE CARE OF EXISTING PLANT MATERIAL AND NEWLY LANDSCAPED AREAS DURING CONSTRUCTION.
- 16. STREET TREE LOCATIONS TO BE COORDINATED WITH DRIVEWAY, FIRE HYDRANT, STREET LIGHT LOCATIONS AND OTHER UTILITIES AS REQUIRED.
- GENERAL NOTES FOR LANDSCAPE PLAN 1. CHANGE RED TEXT DEPENDING ON CONDITIONS

PHOSPHOROUS.

GENERAL NOTES - PLANT MIX

AMMONIA SALT, AND 1/2 IN THE FORM OF ORGANIC NITROGEN.

TOPSOIL: FERTILE, FRIABLE NATURAL TOPSOIL OF LOAMY CHARACTER, WITHOUT ADMIXTURE OF SUBSOIL MATERIAL, OBTAINED FROM A WELL-DRAINED ARABLE SITE, REASONABLY FREE FROM CLAY, LUMPS, COARSE SANDS, STONES, PLANTS, ROOTS, STICKS, AND OTHER FOREIGN MATERIALS, WITH ACIDITY RANGE BETWEEN pH 6.0 AND 6.8.

IDENTIFY SOURCE LOCATION OF TOPSOIL PROPOSED FOR USE ON THE PROJECT. PROVIDE TOPSOIL FREE OF SUBSTANCES HARMFUL TO THE PLANTS, WHICH WILL BE

PEAT MOSS: BROWN TO BLACK IN COLOR, WEED AND SEED FREE GRANULATED RAW PEAT OR BALED PEAT, CONTAINING NOT MORE THAN 9% MINERAL ON A DRY BASIS.

MANURE: STERILIZED COW OR DEHYDRATED HORSE MANURE, SHREDDED, WEED AND SEED

FREE. FURNISH IN BAGS OR BULK. BONE MEAL: RAW, FINELY GROUND, COMMERCIAL GRADE, MINIMUM 3% NITROGEN, 205

FERTILIZER: COMMERCIALLY APPROVED 12-12-12 (12% NITROGEN, 12% PHOSPHORIC ACID, AND 12% POTASH BY WEIGHT). 1/4 OF NITROGEN IN THE FORM OF NITRATES; 1/4 IN THE FORM OF

PROVIDE PRE-MIXED PLANTING MIXTURE FOR USE AROUND THE ROOT BALL/ROOTS OF THE PLANTS CONSISTING OF 5 PARTS TOPSOIL, 1 PART PEAT MOSS, 1 PART MANURE, 10 LBS. FERTILIZER (PER CUBIC YARD) AND 2 1/3 LBS. OF BONE MEAL (PER CUBIC YARD).

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Drawn By BMG **Project Mgr.** DAS

Drawing File

X-Reference

No. Revision/Issue

REVISED

Date

08321006-PLA-06

02/13/17

BG|02/13/1


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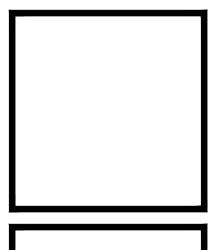


Sheet Title LANDSCAPE DETAILS Project No. 08321.02 1'=20' Sheet No. File No. 08-321

Scale







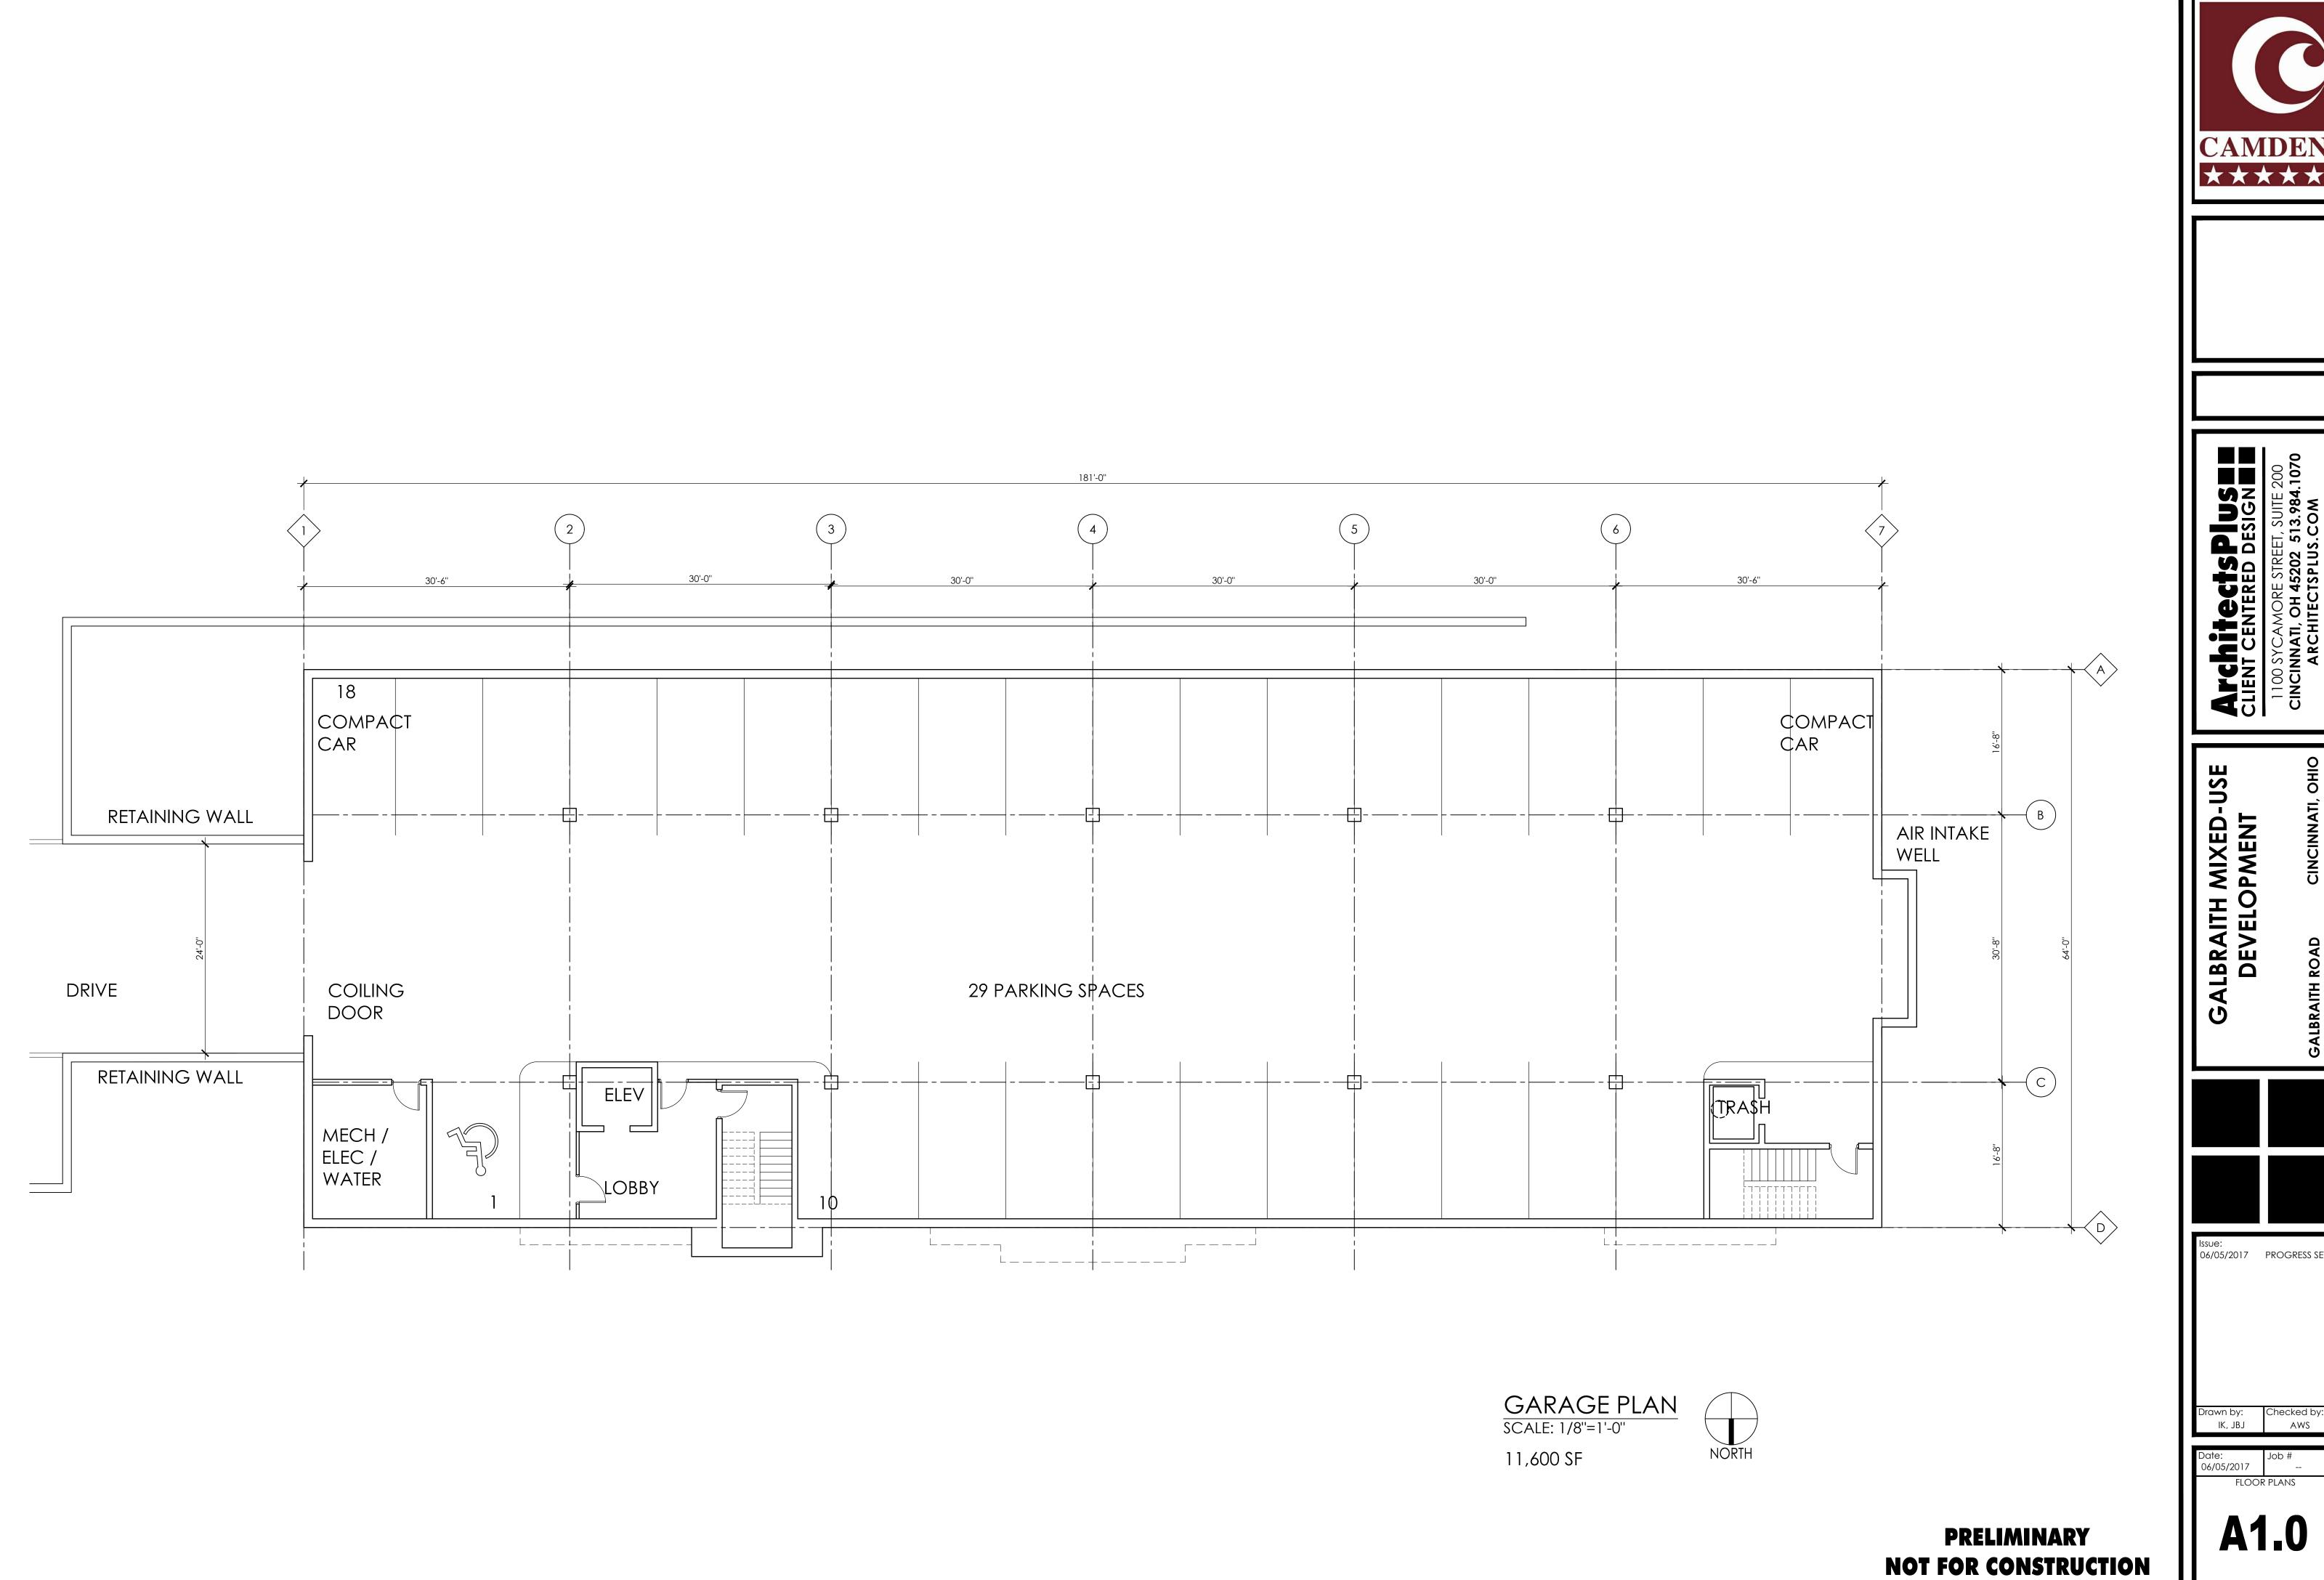


Issue: 06/05/2017 PROGRESS SET

FLOOR PLANS

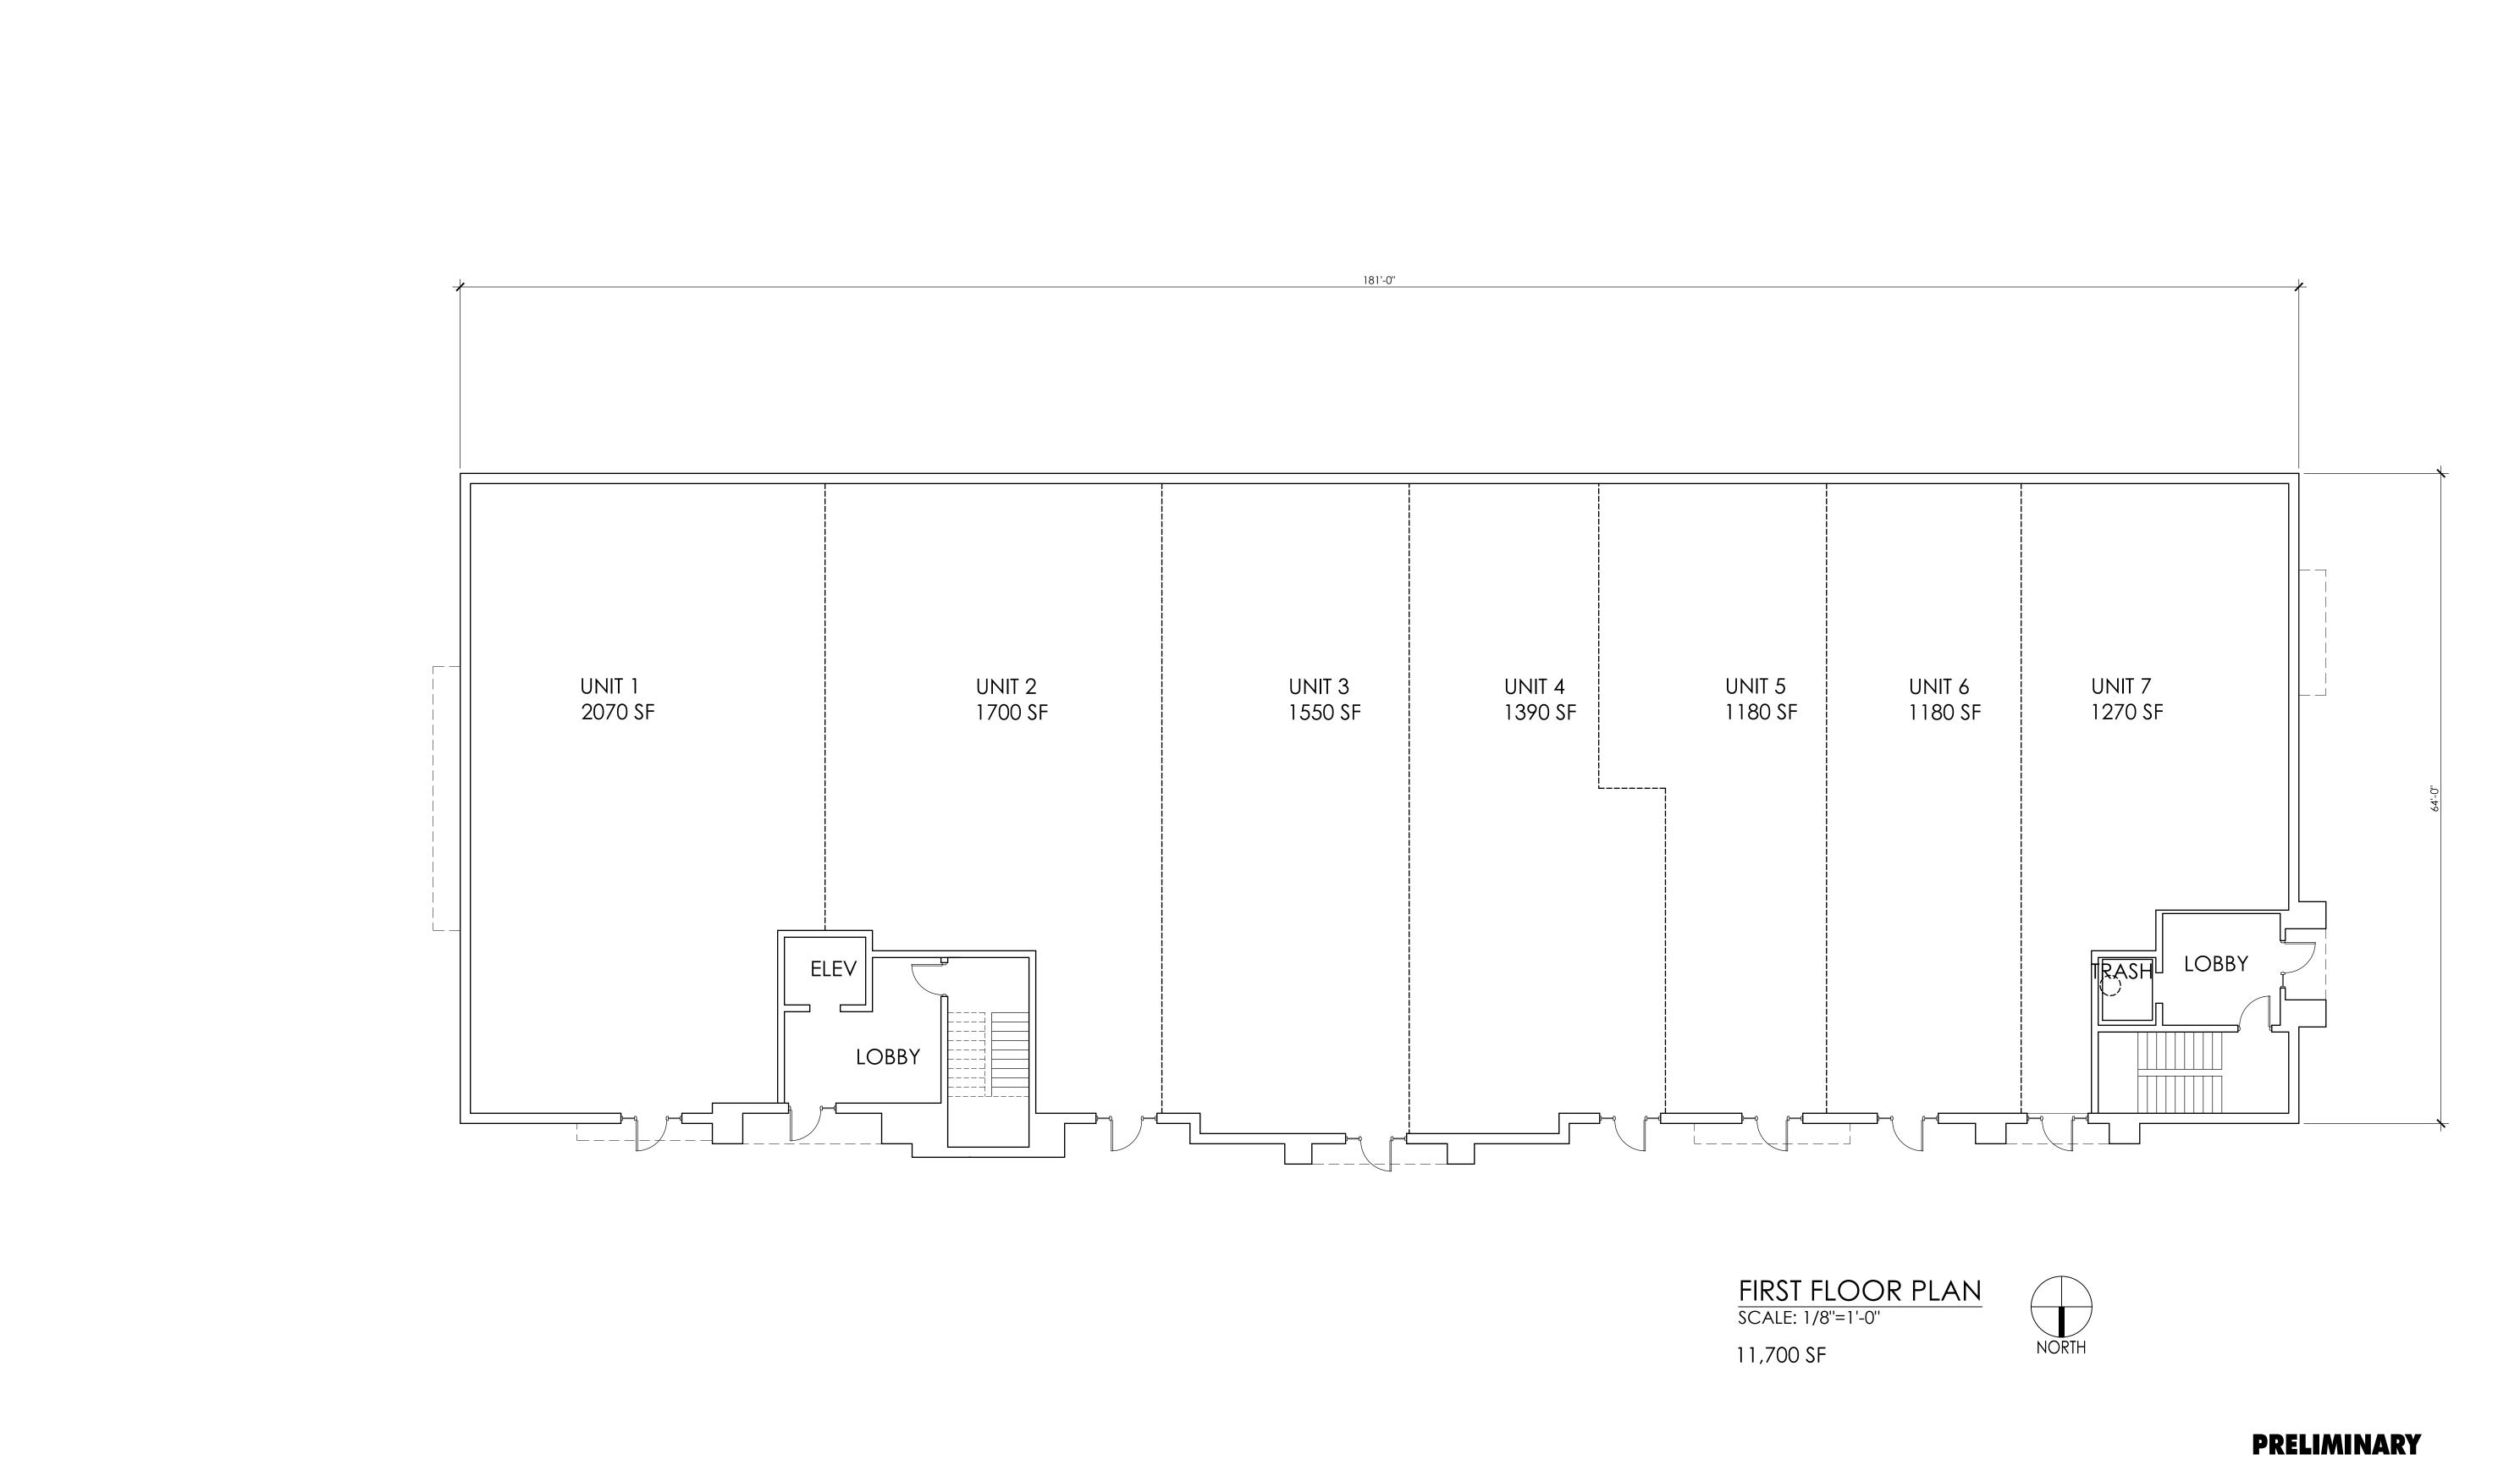

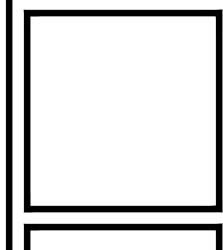

SALBRAITH MIXED-I

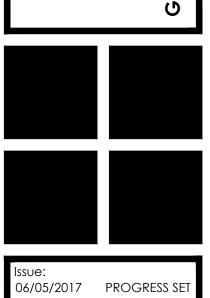



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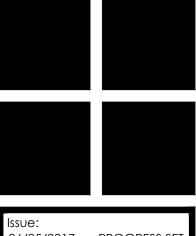
Checked by: AWS Drawn by: IK, JBJ Date: 06/05/2017

FLOOR PLANS


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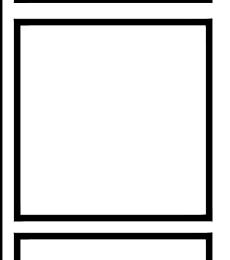


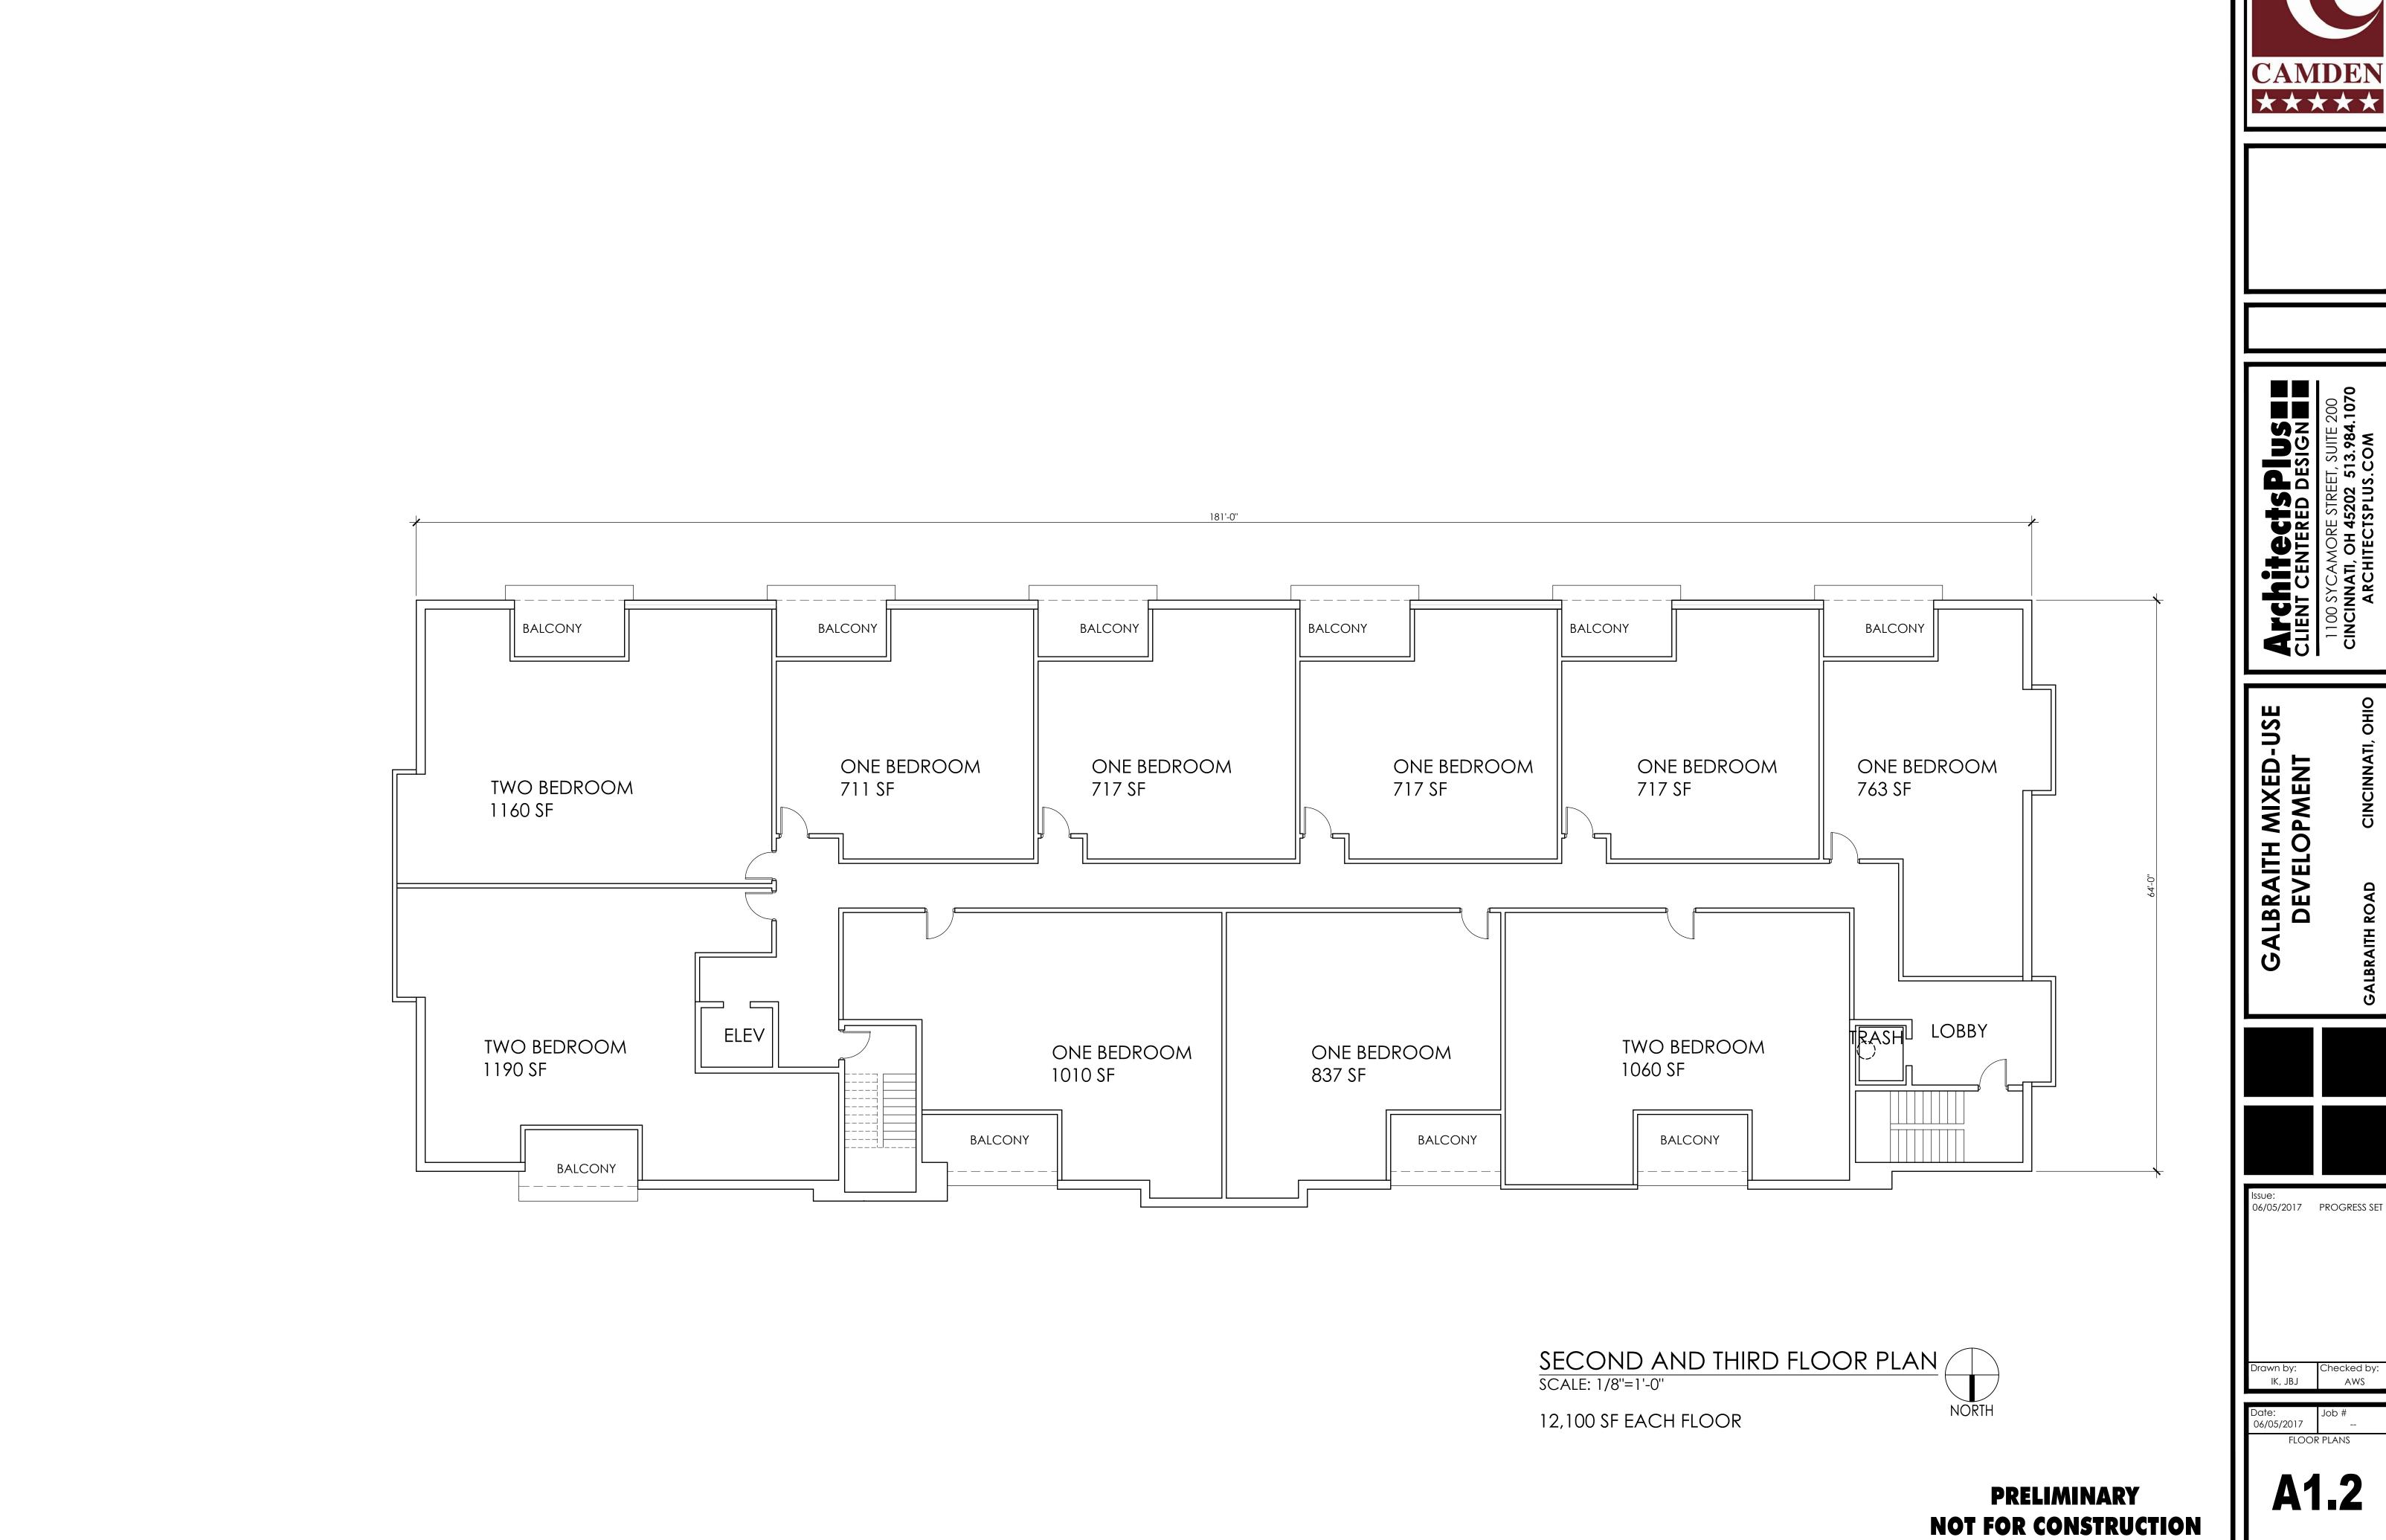

FLOOR PLANS

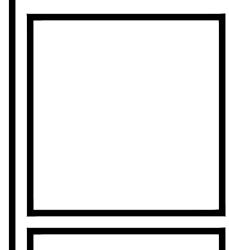


CAMDEN * * * *

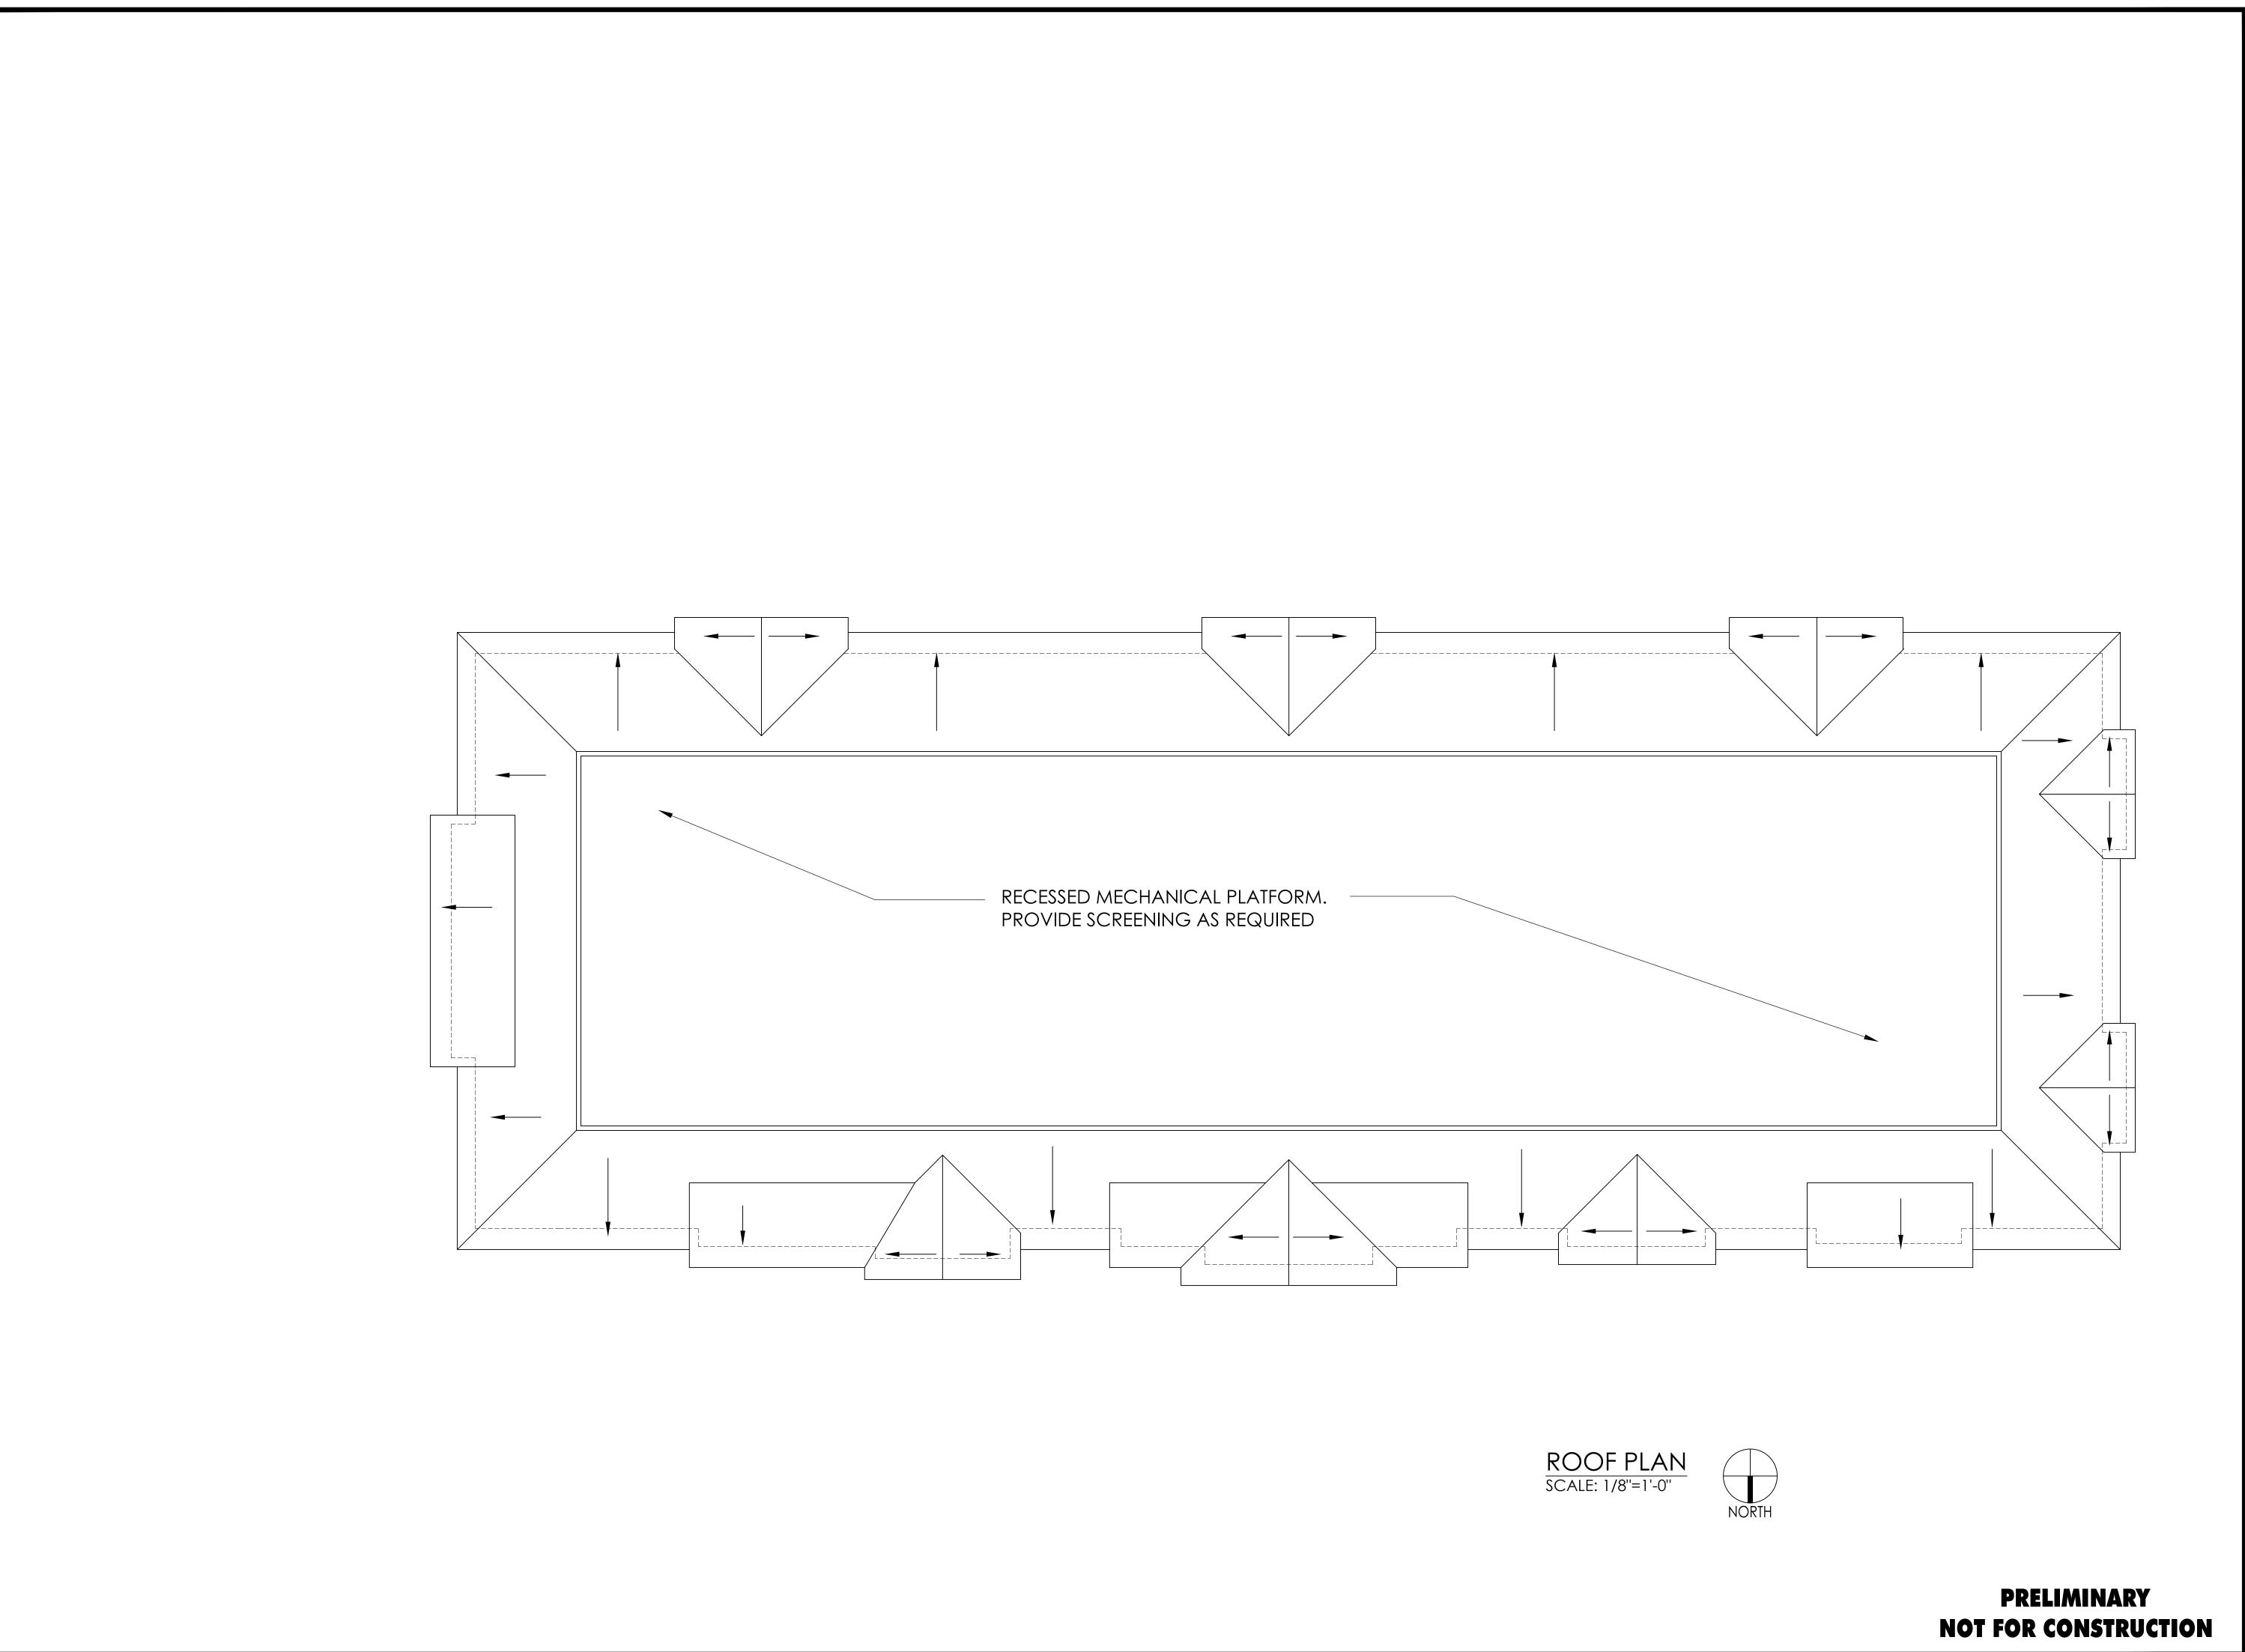

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JATI, OH 45202 513.984.1070
RCHITECTSPLUS.COM

SALBRAITH MIXED-USE DEVELOPMENT

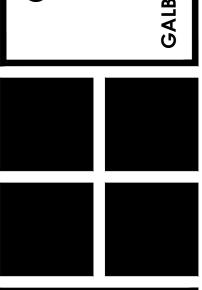


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06/05/2017 PROGRESS SET

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Date: Job # -FLOOR PLANS



CAMDEN * * * *

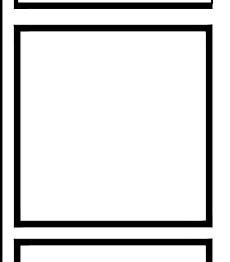


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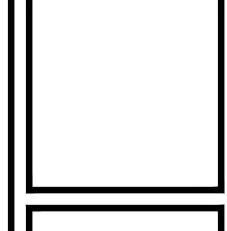
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Date: Job # -
FRONT ELEVATION

A2.1



CAMDEN * * * *

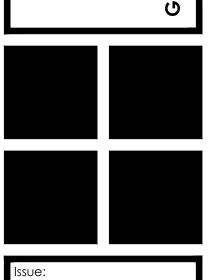

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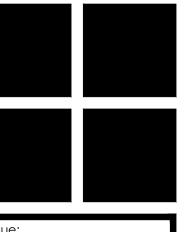
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SALBRAITH MIXED-USE
DEVELOPMENT

GALBRAITH ROAI



Issue:
06/05/2017 PROGRESS SET

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Date: Job #

06/05/2017 -SIDE AND BACK
EXTERIOR ELEVATIONS

A2.2